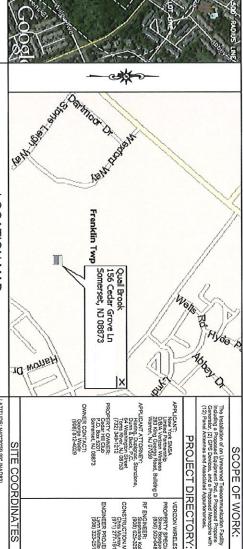
NEW YORK SMSA LIMITED PARTNERSHIP WIRELESS d/b/a

156 CEDAR GROVE LANE SOMERSET, NJ 08873 SOMERSET COUNTY

QUAIL BROOK



(TYPICAL DRAFTING STANDARDS FOR ALL SHEETS) Light, Upper And Lower Case Lottering
When Labeling Edding Features
BOLD UPPER CASE LETTERING WHEN LABELING
PROPOSED FEATURES

TIA 607 COMMERCIAL BUILDING GROUNDING AND BONDING REQUIREMENTS FOR TELECOMMUNICATIONS

BOARD SECRETARY BOARD CHAIRMAN

DATE DATE

SCALE: AS NOTED DATE: 10/02/15

DRAWN BY: JM CHECKED BY: PC

DRAWING TITLE: COVER PAGE

DATE

DRAWING NO.:

PAGE NO .:

7

1 of 23

ANSITTA 222-G, STRUCTURAL STANDARDS FOR STEEL ANTENNA TOWER AND ANTENNA SUPPORTING STRUCTURES: AMERICAN CONCRETE INSTITUTE (ACI) 318, DUILDING CODE REQUIREMENTS FOR STRUCTURAL CONCRETE SUBCONTRACTOR'S WORK SHALL COMPLY WITH THE LATEST APPROVED OF THE FOLLOWING STANDARDS

WERICAN INSTITUTE OF STEEL CONSTRUCTION (AISC), WANUAL OF STEEL CONSTRUCTION, ASD, NINTH EDITION

NETTITITE POR ELECTRICAL AND ELECTRONICS ENGINEERS (IEEE) 81, OUDE FOR MUZUIRNO EARTH RESISTIVITY, GROUND MEDANCE, AND EARTH SURFACE POTENTIALS, OF A OROUND SYSTEM (IEEE 1100 (1989) RECOMMENDED PRACTICE FOR POWERING AND GROUNDING OF ELECTRONIC EQUIPMENT

IEEE C2 NATIONAL ELECTRIC SAFETY CODE, LATEST VERSION

TELCORDIA GR-1275 GENERAL INSTALLATION REQUIREMENTS

ANSI T1.311, FOR TELECOM - DC POWER SYSTEMS - TELECOM, ENVIRONMENTAL PROTECTION

TR ALY COMPLICTS DETWIEM SECTIONS OF LISTED CODES AND STANDARDS RECARDING MATERIAL, METHODS OF NISTRUCTION OR OTHER REQUIREMENTS, THE MOST RESTRICTINE REQUIREMENT SHALL DOVERN, WHERE THERE IS CONFLICT TYMENS A GENERAL REQUIREMENT AND A SPECIFIC REQUIREMENT, THE SPECIFIC REQUIREMENT SHALL GOVERN.

DWG. TITLE

KEY MAP

DWG. Z18 Z19

DWG. TITLE

722

ELECTRICAL CODE: NATIONAL FRE PROTECTION ASSOCIATION (NFPA) 70 - 2014, NATIONAL ELECTRICAL CODE, AS ACOPTED BY NEW AREASE? BUILDING CODE: INTERNATIONAL BUILDING CODE (IBC), 2015 AS ADOPTED BY NEW JERSEY]

NFPA 780 - 2006, LIGHTNING PROTECTION CODE

SUBCONTRACTORS WORK SHALL COMEN WITH ALL APPLICABLE INTOME. STATE, AND LOCAL CODES A ADDRITED BY THE LOCAL AUTHORITY MANNOLARISDICTION AND 1908 THE LOCATION, IT WE STATE, AND ADDRIED CODES AND STANDARDS IN EFFECT ON THE DATE OF CONTRACT AWARD SHALL COVERN THE DESIGN.

SLOCK: 424.12 OT: 5.01

VNSHIP: TOWNSHIP OF FRANKLIN

COK: 424.12

ZONE: R-40 SINGLE FAMILY RESIDENTIAL

S.5.01

MAP #: 76

APPROVALS

APPROVED AS NOTED DISAPPROVED REVISE

SITE ADDRESS: 156 CEDAR GROVE LANE SOMERSET, NJ 08873 SOMERSET COUNTY SDG PROJECT #: 15VNJ015

SITE NAME: QUAIL BROOK

LEGAL DESCRIPTION:

APPLICABLE CODES LOCATION MAP

LATITUDE: N40"30"59.99" (NAD83) LONGITUDE: W74"31"14.40" (NAD83) GROUND ELEVATION: 85" +/- (NAVD88)

NO. ISSUE OR REVISION DATE 3 ZONING RESOLUTION 02/12/18 HW

뭠

PRELIMINARY AND FINAL SITE PLAN PROJECT TITLE:

DARK LINES REPRESENT PROPOSED FEATURES Light Lines Represent Existing Features

SCOPE OF WORK:

PROJECT DIRECTORY: VERIZON WIRELESS

PROPERTY SPECIALIST: Stove Bosque (856) 505-0482

RF ENGINEER: Stophanio Koles (908) 625-3293

CONSTRUCTION MANAGER: Chris Murray (971) 277-1914

ENGINEER PROJECT MANAGER: Lynn Manvillo (908) 323-2513

RECIEVED 08.12.19 09/30/19 RECIEVED 01.14.19 07/12/19

ADDITIONAL TOWNSHIP COMMENTS

COMMENTS

06/29/18 10/05/18 VBF

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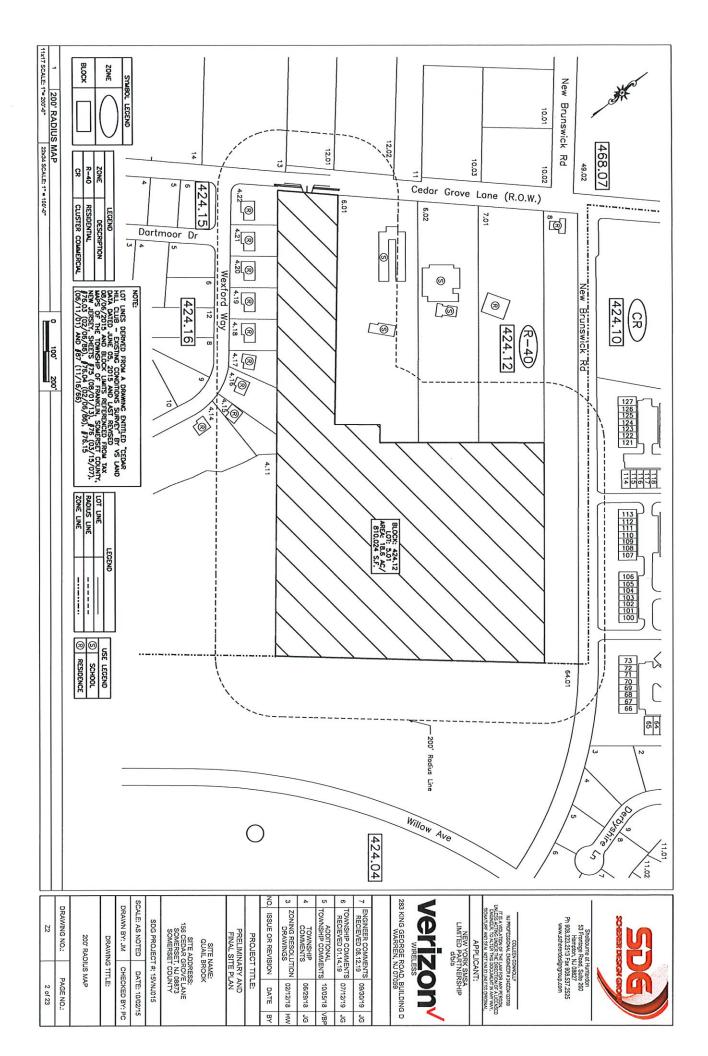
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283 KING GEORGE ROAD, BUILDING D WARREN, NJ 07059

NJ PROFESSIONAL ENGINEER & RACIDATISTRO

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SIGNATURE AND SEAL NOT VALID UNLESS ORIGINAL. NEW YORK SMSA LIMITED PARTNERSHIP d/b/a APPLICANT:

Shelbourne at Hunterdon 53 Frontage Road, Suite 260 Frontage Road, Suite 260 Humpton, NJ 08272 Ph 908.323.2513 Fax 908.537.2525 www.schererdesigngroup.com



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PROPERTY ID PROPERTY LOCATION

5 TOWNSHIP COMMENTS 10/05/18 VBP

4 TOWNSHIP COMMENTS 06/29/18 JG
COMMENTS 06/29/18 JG
3 ZONING RESOLUTION 02/12/18 HW

7 ENGINEER COMMENTS 09/30/19 JG
RECIEVED 08.12.19 09/30/19 JG
TOWNSHIP COMMENTS 07/12/19 JG
RECIEVED 01.14.19

283 KING GEORGE ROAD, BUILDING D WARREN, NJ 07059 **Verizon**

NO. ISSUE OR REVISION DATE BY

PROJECT TITLE:
PRELIMINARY AND
FINAL SITE PLAN

SCALE: AS NOTED DATE: 10/02/15

SDG PROJECT #: 15VNJ015

SITE ADDRESS: 156 CEDAR GROVE LANE SOMERSET, NJ 08873 SOMERSET COUNTY

SITE NAME: QUAIL BROOK

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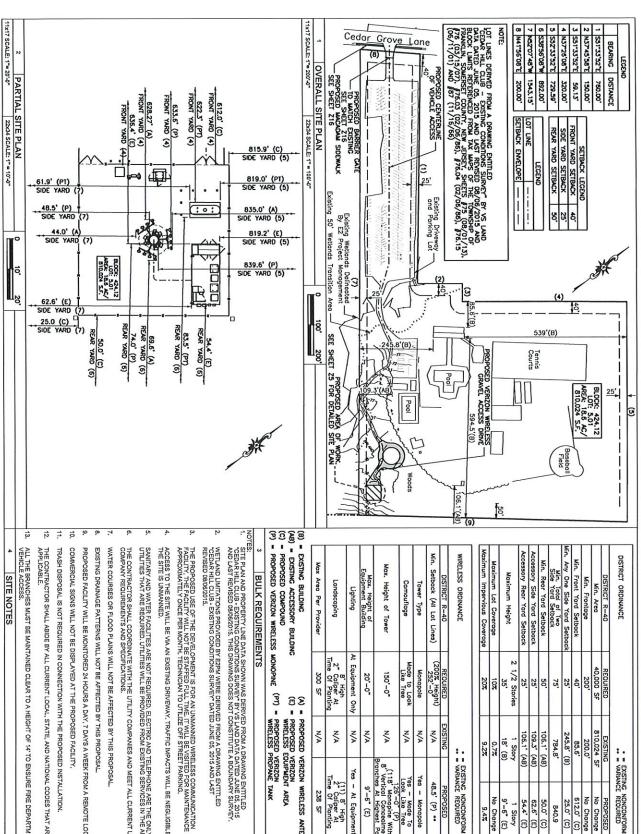
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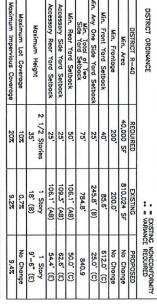
200' PROPERTY OWNERS LIST



NEW YORK SMAL

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Max Area Per Provider 300 SF	Landscaping 2" Caliper At Time Of Planting	Lighting At Equipment Only	Max. Height of 20*-0* Equipment Building	Max. Height of Tower 150'-0"	Camouflage Made to Look	Tower Type Monopole	Min. Setback (All Lot Lines) (200%, Height)	DISTRICT R-40 REQUIRED	WIRELESS ORDINANCE
SF N/A	righ per At N/A Planting	ent Only N/A	-0" N/A	-0" N/A	Tree N/A	pole N/A	reight) N/A	IRED EXISTING	
'A 238 SF	(11) 8" High 2" Coliper At Time Of Planting	'A Yes - At Equipment	'A 9'-6" (E)	A (118' Monopine With A 8' Vertical Concediment Branches At Highest Point	۲,	'A Yes - Monopole	'A 48.5' (P) ••	ING PROPOSED	• • VARIANCE REQUIRED

SITE PLAN AND PROPERTY LINE DATA SHOWN WAS DERIVED FROM BEAWING ENTITLED STORED FROM THE JUSTIAN CONDITIONS SUPPLYETY BY VIS LAND DATA DATED JUNE 15, 275 AND LAST REVISED 08/08/2015, THIS DRAWING DOES NOT CONSTITUTE A BOUNDARY SURVEY. BULK REQUIREMENTS

WETLAND IMITATIONS PROVIDED BY EZPM WERE DERIVED FROM A DRAWING ENTITLED YOBDAR HILL CLIB - EXISTING CONDITIONS SURVEY DATED JUNE 05, 2015 AND LAST REVISED 08/06/2015.

ACCESS TO THE SITE WILL BE VIA AN EXISTING DRIVEWAY, TRAFFIC IMPACTS WILL BE NEGLIGIBLE SING

THE CONTRACTOR SHALL COORDINATE WITH THE UTILITY COMPANIES AND MEET ALL CURRENT UTILIT COMPANY REQUIREMENTS AND SPECIFICATIONS. SANITARY AND WATER FACILITIES ARE NOT REQUIRED. ELECTRIC AND TELEPHONE ARE THE ONLY UTILITIES THAT ARE REQUIRED. UTILITIES WILL BE PROVIDED FROM EXISTING SERVICES IN THE AREA.

WATER COURSES OR FLOOD PLAINS WILL NOT BE AFFECTED BY THIS PROPOSAL

COMMERCIAL SIGNS WILL NOT BE DISPLAYED AT THE PROPOSED FACILITY.

PROPOSED FACILITY WILL BE MONITORED 24 HOURS A DAY, 7 DAYS A WEEK FROM A REMOTE LOCATIO

TRASH DISPOSAL IS NOT REQUIRED IN CONNECTION WITH THE PROPOSED INSTALLATION

THE CONTRACTOR SHALL ABIDE BY ALL CURRENT LOCAL, STATE, AND NATIONAL CODES THAT ARE APPLICABLE.

ALL THE BRANCHES MUST BE MAINTAINED CLEAR TO A HEIGHT OF 14' TO ENSURE FIRE DEPARTMENT VEHICLE ACCESS.

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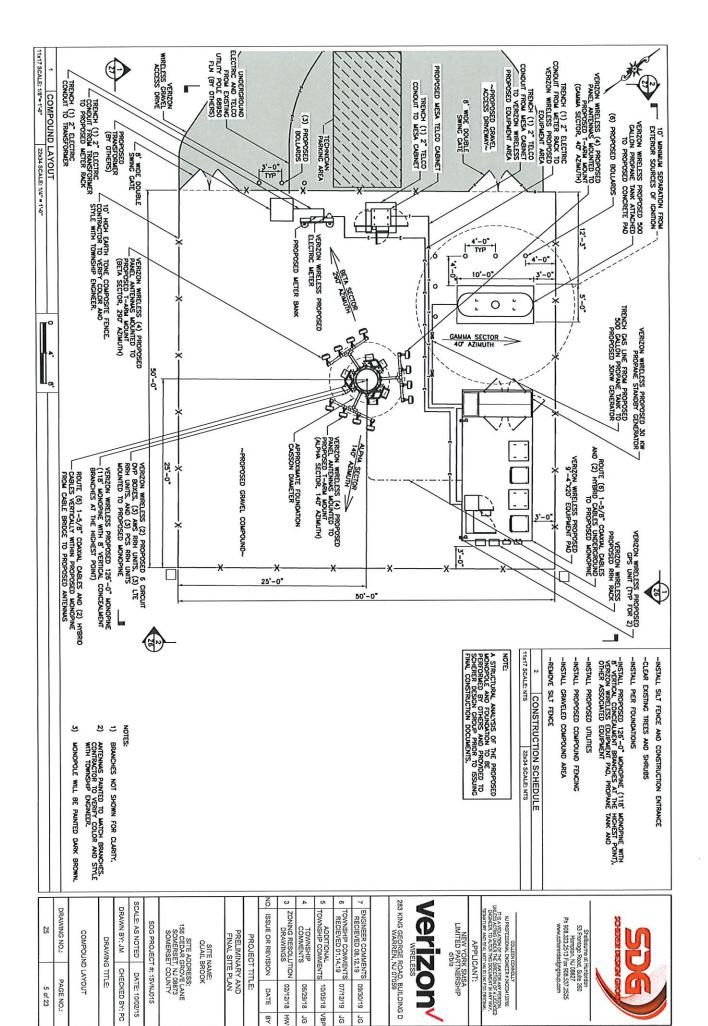
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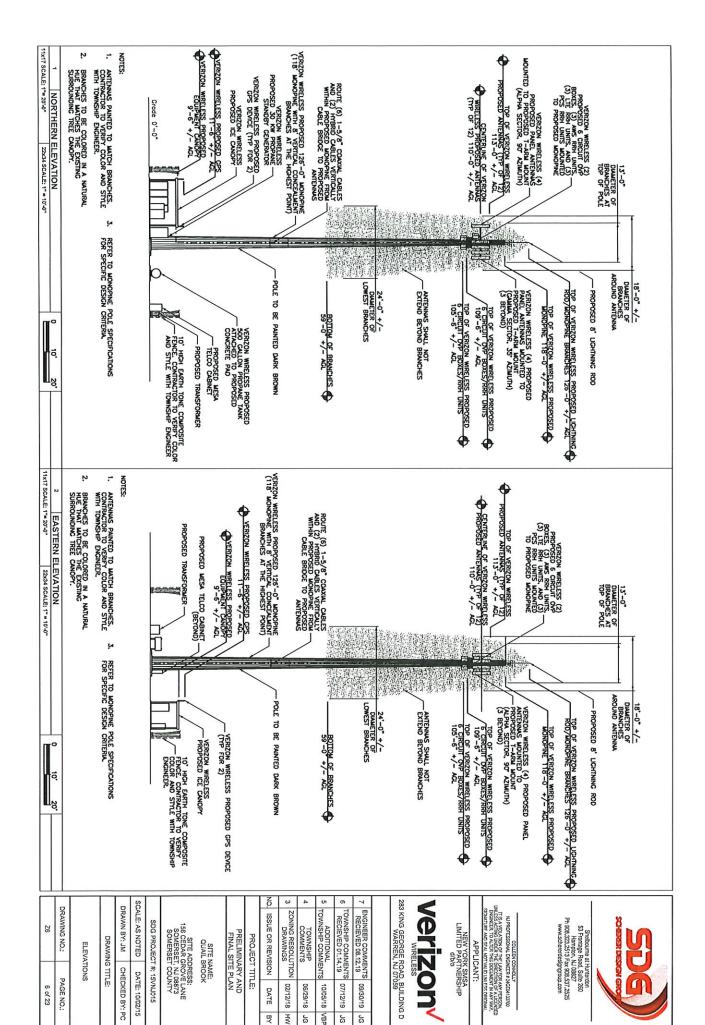
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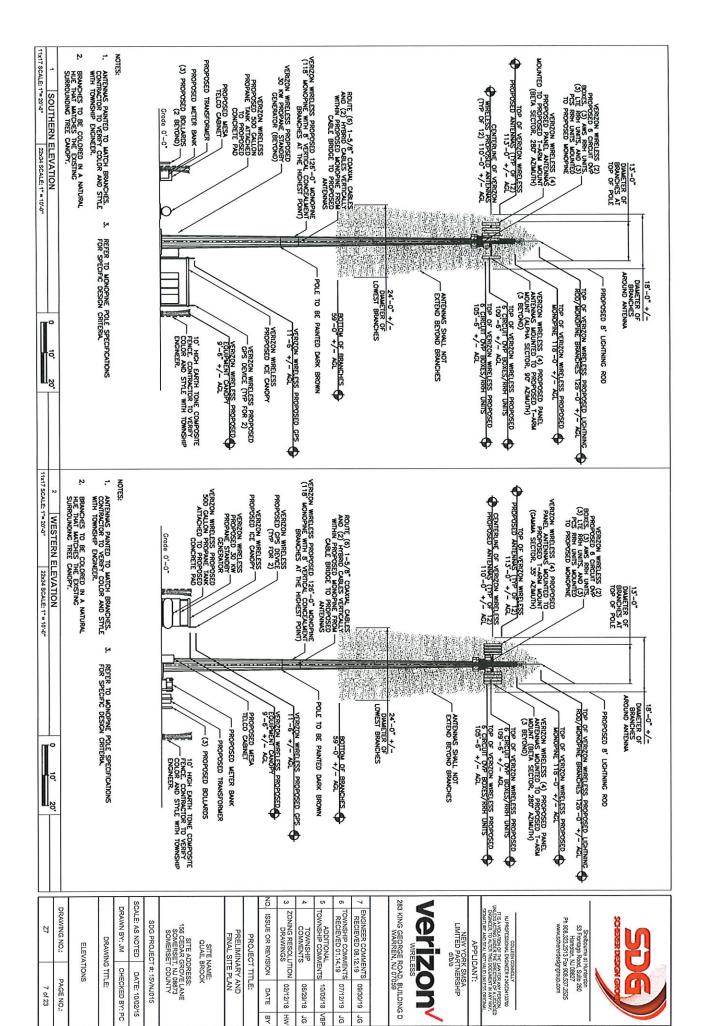
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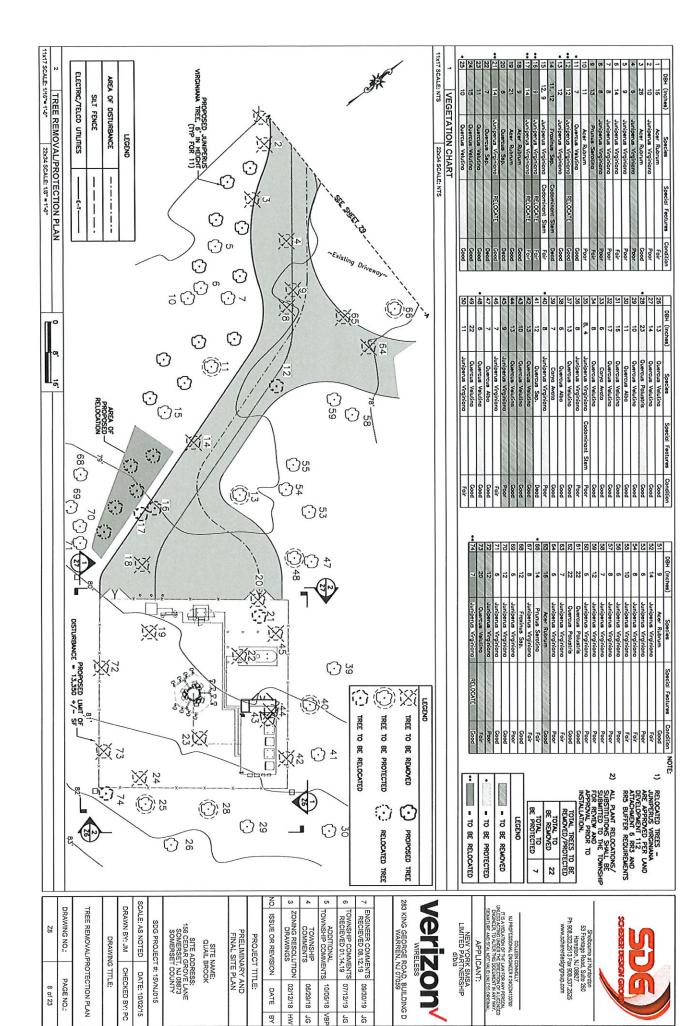
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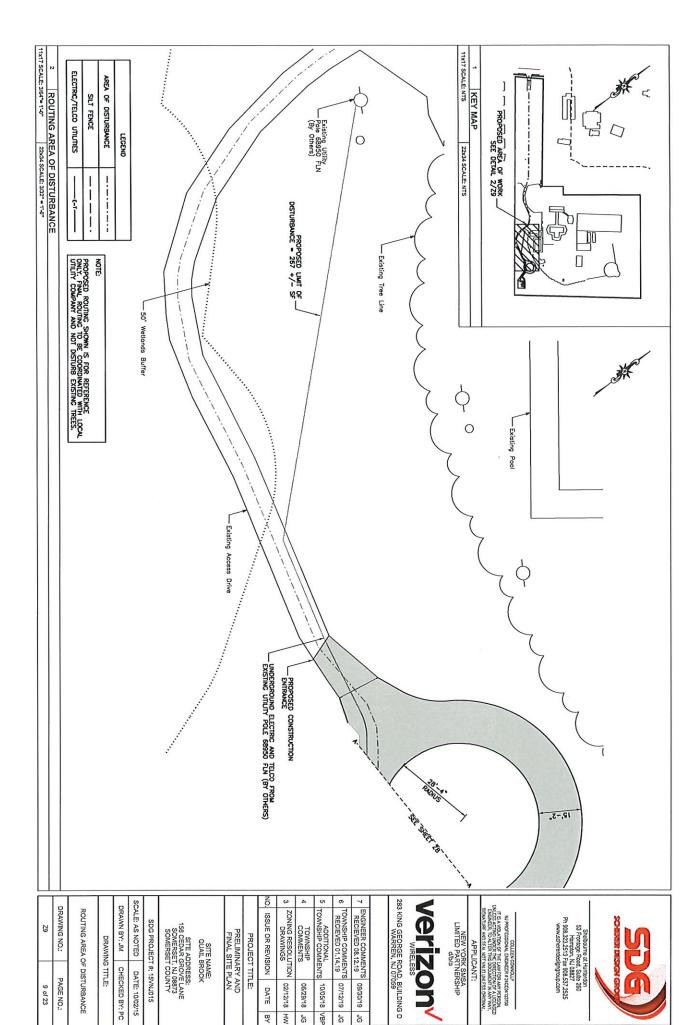




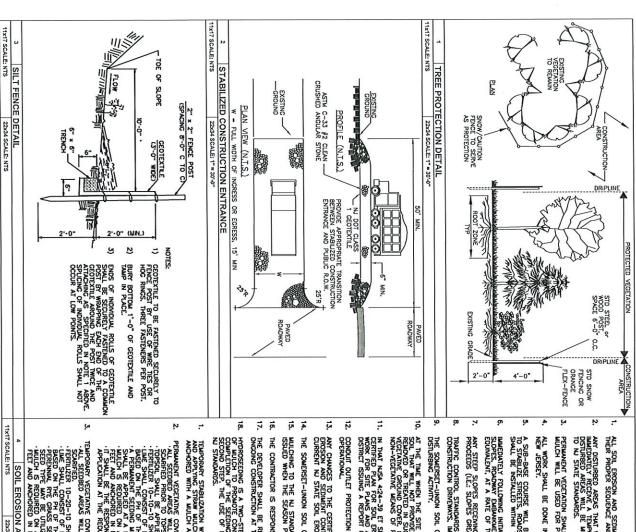
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all soil erosion and sediment control practices shall be installed prior to any major soil disturbance, or in Their proper sequence and maintained until permanent protection is established.

ANY DISTURBED AREAS THAT WILL BE LEFT EXPOSED MORE THAN 30 DAYS AND NOT SUBJECT TO CONSTRUCTION TRAFFIC WILL MANEDWATELY RECEIVE A TELPOPARY SEEDING, IF THE SEASON PREYENTS THE ESTABLISHMENT OF A TELPOPARY COVER, THE DISTURBED AREAS WILL BE MULCHED WITH STRAW OR EQUIVALENT MATERIAL, AT A RATE OF TWO (2) TONS PER ACRE, ACCORDING TO NJ STATE STANDARDS.

PERMANENT VEGETATION SHALL BE SEEDED OR SODDED ON ALL EXPOSED AREAS WITHIN TEN (10) DAYS AFTER FINAL GRADING, MULCH WILL BE USED FOR PROTECTION UNTIL SEEDING IS ESTABLISHED.

ALL WORK SHALL BE DONE IN ACCORDANCE WITH THE NJ STATE STANDARDS FOR SOIL EROSION AND SEDIMENT CONTROL IN NEW JERSEY.

A SUB-BASE COURSE WILL BE APPLIED IMMEDIATELY FOLLOWING ROUGH GRADING AND INSTALLATION OF IMPROVEMENTS IN ORDER TO STABILIZE STREETS, ROUGS, DRAFEMAYS AND PARKING AREAS, IN AREAS WHERE NO UTILITIES ARE PRESENT, THE SUB-BASE SMALL BE INSTALLED WITHIN 15 DAYS OF PRELIMINARY GRADING.

MANDARIEY FOLLOMAG NITIAL, DISTURBANCE OR ROUCH GRADING, ALL CRITICAL AREAS SUBJECT TO EROSION (1.E.: STEEP SLOPES, ROADMAY EMBANKAENTS) WILL RECERG A TEMPORARY SECONG IN COMBINATION WITH STRAW MULCH OR A SUTFABLE EDUNALENT, AT A RATE OF TWO (2) TONS PER ACRE, ACCORDING TO THE NJ STATE STANDARDS.

ANY STEEP SLOPES RECEIVING PIPELINE INSTALLATION WILL BE BACKFILLED AND STABILIZED DAILY, AS THE INSTALLATION PROCEEDS (I.E.: SLOPES GREATER THAN 3:1).

TRAFFIC CONTROL STANDARDS REQUIRE THE INSTALLATION OF A 50"X30"X6" PAD OF 1 1/2" OR 2" STONE, AT ALL CONSTRUCTION DRIVENAYS, IMMEDIATELY AFTER INITIAL SITE DISTURBANCE.

THE SOMERSET-UNION SOIL CONSERVATION DISTRICT SHALL BE NOTIFIED IN WRITING 48 HOURS IN ADVANCE OF ANY LAND DISTURBING ACTIVITY.

AT THE THE WHEN THE SITE PREPARATION FOR PERMANENT VEGETATIVE STREELIZATION IS COING TO BE ACCOMPLISHED, ANY SOLL AND PROVIDE A SUITABLE ENROWMENT TO SUPPORT ADEQUATE VEGETATIVE GROUND COYERS, SHALL BE REMOVED OR TREATED AND SUITA A WAY THAT WHILL PERMANENTY ADJUST THE SOIL CONDITIONS AND RENDER IT SUITABLE FOR YEGETATIVE CROUND COVER, IT THE REMOVAL OR TREATMENT OF THE SOIL WILL NOT PROVIDE SUITABLE CONDITIONS, NON-YEGETATIVE MAPAS OF PERMANENT GROUND STABILIZATION WILL HAVE TO BE EMPLOYED.

IN THAT HUSA 4:24—39 ET SED., REQUIRES THAT NO CERTIFICATE OF OCCUPANCY BE ISSUED BEFORE THE PROVISIONS OF THE CERTIFIED PLAN FOR SOIL, EROSION AND SEDMENT CONTROL HAVE BEEN COMPLED WITH FOR PERMANENT MEASURES, ALL SITE WORK FOR SITE PLANS AND ALL WORK ARGUND INMODIFIED, LOST IN SUBDIVISIONS, WILL HAVE TO BE COMPLETED PRIOR TO THE DISTRICT ISSUING A REPORT OF COMPLANCE FOR THE ISSUANCE OF A CERTIFICATE OF OCCUPANCY BY THE MUNICIPALITY.

CONDUIT OUTLET PROTECTION MUST BE INSTALLED AT ALL REQUIRED OUTFALLS PRIOR TO THE DRAINAGE SYSTEM BECOMING OPERATIONAL.

ANY CHAMPES TO THE CERTIFIED SOIL EROSION AND SEDMENT CONTROL. PLAN WILL REQUIRE THE SUBMISSION OF REVISED SOIL EROSION AND SEDMENT CONTROL PLANS TO THE DISTRET FOR RE-CERTIFICATION. THE REVISED PLANS MUST MEET ALL CURRENT AL STATE SOIL EROSION AND SEDMENT CONTROL STANDARDS.

THE SOMERSET-UNION SOIL CONSERVATION DISTRICT SHALL BE NOTIFIED OF ANY CHANGES IN OWNERSHIP.

mulching to the NJ Standards is required for obtaining a conditional report of compliance, conditionals are Issued when the SPASON prohibits seeding.

THE CONTRACTOR IS RESPONSIBLE FOR KEEPING ALL ADJACENT ROADS CLEAN DURING THE LIFE OF THE CONSTRUCTION PRO

THE DEVELOPER SHALL BE RESPONSIBLE FOR REMEDIATING ANY EROSION OR SEDIMENT PROBLEMS THAT ARISE AS A RESULT ONGOING CONSTRUCTION AT THE REQUEST OF THE SOMERSET-UNION SOIL CONSERVATION DISTRICT.

HYDROSEEDING IS A TWO-STEP PROCESS. THE FIRST STEP INCLUDES SEED, FERTILIZER, LIME, ETC., ALONG WITH MINIMAL AN OF MUICH TO PROMOTE CONSISTENCY, GOOD SEED TO SOIL CONTACT, AND GIVE A VISUAL INDICATION OF CONFRAGE. UPON COMPLETION OF THE SEEDING OPERATION, HYDRO-MUICH SHOULD BE APPLIED AT A RATE OF 1500 LBS. PER ACRE IN THE SECOND STEP. THE USE OF HYDRO-MUICH, AS OPPOSED TO STRAW, IS LIMITED TO OPTIMUM SEEDING DATES AS LISTED IN NU STANDARDS. STABILIZATION NOTES

TEMPOARY STABILIZATION WITH MUICH ONLY SMALL BE ACCOMPLISHED BY CROUNDE THE AFEKS AS NEEDED, OR AS FEASIB AND APPLYING STRAM MUICH AN A NET OF 90—115 POUNDES PER 1,000 SQUARE FEET, MUICHED AREKS MUST BE PROPE ANCHORED WITH A MUICH ANCHORING TOOL, LIQUID BINDERS, OR NETTING TIE DOWN.

TEMPORARY VEGETATIVE COVER FOR SOIL STABILIZATION SHALL PROCEED AS FOLLOWS: FÉRTILIZES 10—20—10 SMALL BE APPLIED AT A RATE OF 11 POUNDS PER 1,000 SOUMEE FEET.
LIME SMALL COMSSIT OF DOCUMENT CHAESTONE AND BE APPLIED AT A RATE OF 30 POUNDS PER 1,000 SOUMEE FEET. OI
BASED ON THE PHIS THE SOUL BE APPLIED AT A MINIMUM RATE OF 1 POUND PER 1,00 SOUMEE FEET. AN ALTERWINED THE MINIMUM RATE OF 1 POUND PER 1,00 SOUMEE FEET. AN ALTERWINED THE MINIMUM RATE OF 70—90 POUNDS PER 1,000 SOUMED ON ALL SEEDING. STRAW MULCH SHALL BE APPLIED AT A RATE OF 70—90 POUNDS PER 1,000 SOU

Shelbourne at Hunterdon 53 Frontage Road, Sulfe 260 Frontage Road, Sulfe 260 Hampton, NJ 08827 Ph 908,323,2513 Fax 908,537,2525 www.schererdesigngroup.com

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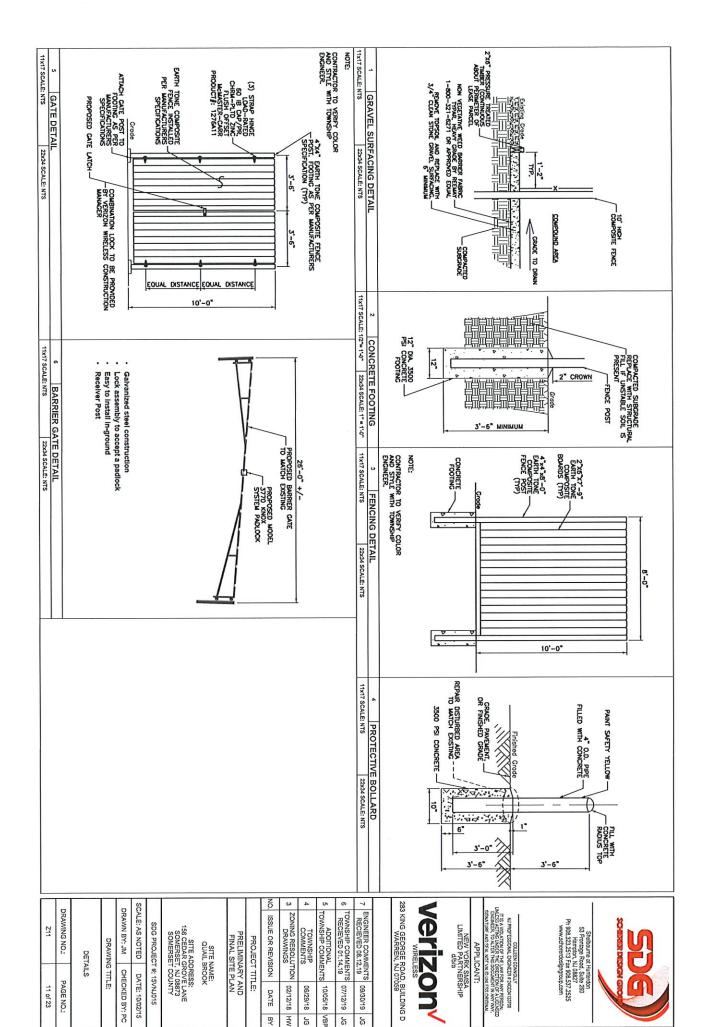
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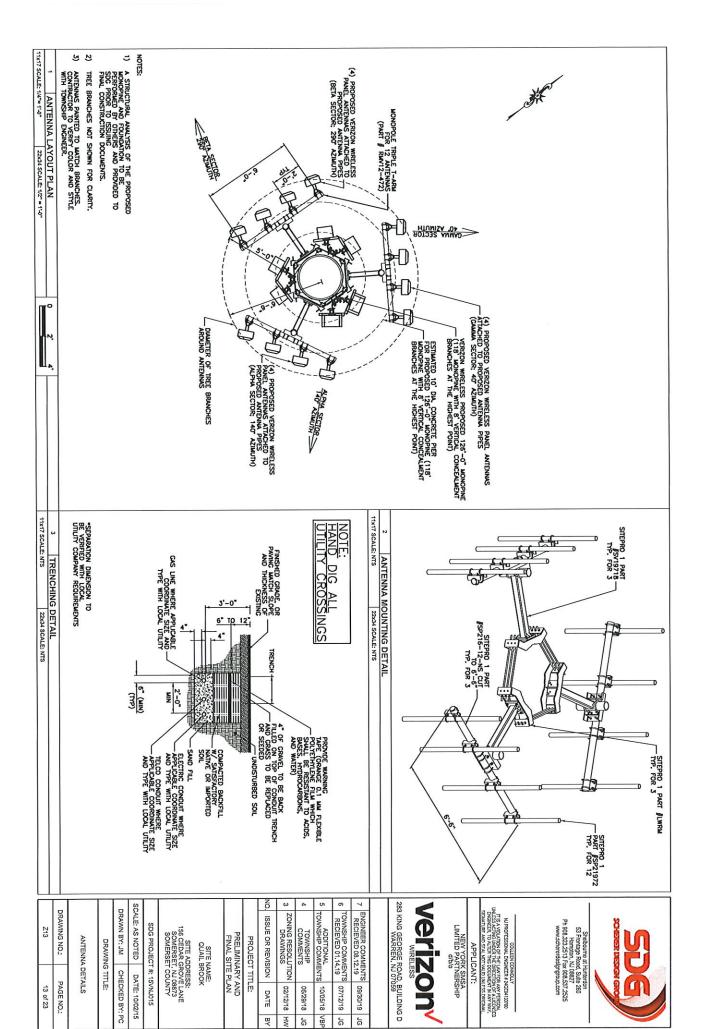
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10 of 23	PAGE NO .:	AND	ļ'n	CHECKED BY:	DATE: 10/02/15	15VNJ015	S: LANE JABR73 JATY	*	PLAN	Ë	DATE	02/12/18	06/29/18	10/05/18	07/12/19	09/30/19
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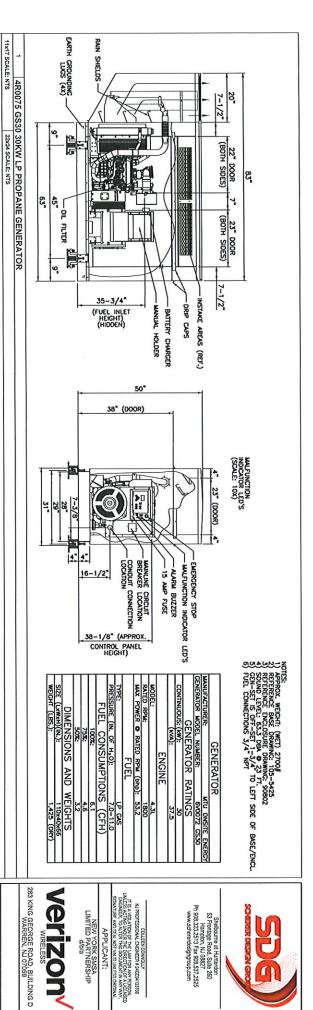


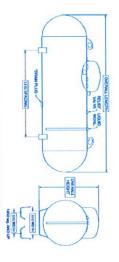
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Z12 12 of 23	NO.:	DETAILS	DRAWING TITLE:	DRAWN BY: JM CHECKED BY: PC	SCALE: AS NOTED DATE: 10/02/15	SDG PROJECT #: 15VNJ015	SITE ADDRESS: 156 CEDAR GROVE LANE SOMERSET, U. 08873 SOMERSET COUNTY	SITE NAME: QUAIL BROOK	PRELIMINARY AND FINAL SITE PLAN	PROJECT TITLE:	NO. ISSUE OR REVISION DATE BY	3 ZONING RESOLUTION 02/12/18 HW	4 TOWNSHIP 06/29/18 JG	5 TOWNSHIP COMMENTS 10/05/18 VBP	6 TOWNSHIP COMMENTS 07/12/19 JG	7 RECIEVED 08.12.19 09/30/19 JG	150	Shebourna at Humerden Si Frontage Road, Sille 280 19 Frontage Road, Sille 280 10 Frontage Road, Building D	SDG



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TOWNSHIP COMMENTS 10/05/18 VBP

COMMENTS

06/29/18 JG

RECIEVED 08.12.19 09/30/19

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ZONING RESOLUTION 02/12/18 HW

ISSUE OR REVISION

DATE

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PRELIMINARY AND FINAL SITE PLAN PROJECT TITLE:

SITE NAME: QUAIL BROOK

APPROXIMATE ABOVEGROUND VESSEL DIMENSIONS AND SPECIFICATIONS WATER DIAMETER HEAD OVERALL OVERALL LEG** LEG** WEIGHT ***QUANTITY

1450 Wg.	1000 wg.	500 wg.	*320 wg.	*250 wg.	*120 wg.	CAPACITY	WANTER
40 1/2	41"	37 1/2"	30"	30"	24*	(00)	WALCH CHARLES
emp.		Hemi.	Heml.	Hemi.	Ellip.	34AL	2000
1/4	16'	10'	9'-7"	7-10"	8.8	LENGTH	CALLONE
4-4	4'-3"	4	31-61	3'-6"	2'-10"	HEIGHT	CALLOUR CALLOUR
A- T	1.8"	1'-8"	1:5.	1'-5"	1'-1 1/2"	HIDIM	-
1-17	10'-1"	S ¹	s.	4'-11"	2'-10 1/2" or 3'-11"	SPACING	-
2,000	1,800	950	520	480	260	(lbs.)	
t	17 15	37 30	45	22	108 112	FULL LOAD	4
,	8 18	8 6	٥	9	16 14	PER STACK	4000000

* Leg spacing +/-2", Leg widths and spacing may vary tanks -no holes in legs (one center hole on request). est). 500 and 1000 wg. ck with your salesperson for details, 120, 250, 320 wg. Standard tanks - 2 - 3/4" holes, 15" on center each leg. 1650 wg. and up as

MANUFACTURERS SPECIFICATIONS.

QUALITY STEEL 500 GALLON PROPANE TANK SPECIFICATIONS

11x17 SCALE: NTS

24x36 SCALE: NTS

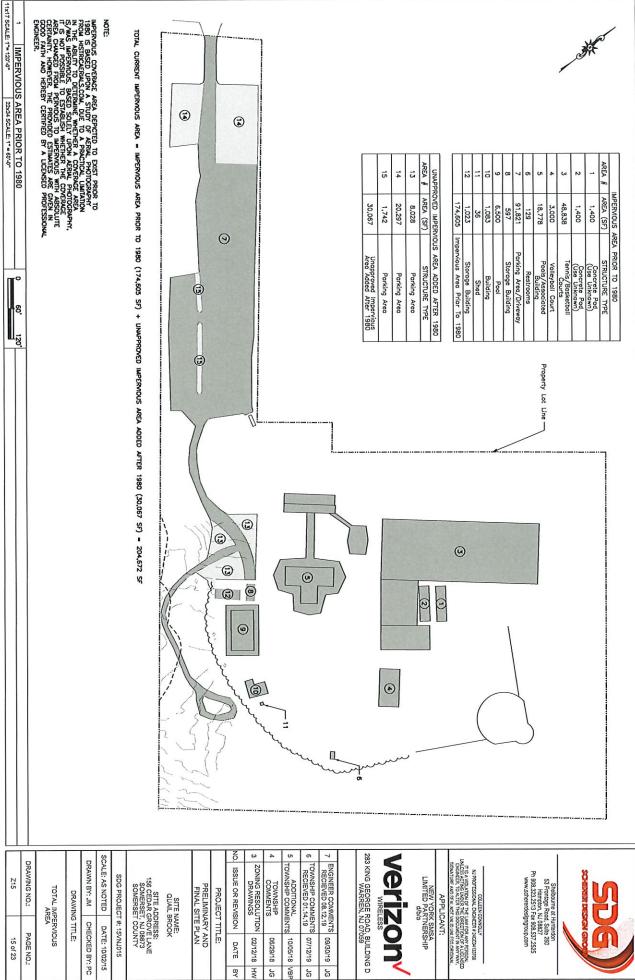
- Rated at 250 psig from -20" f to 125" f. All wessels registered with National Board. All standard wessels Ut listed [Ut 644 - Container Assemblies for tP-Gas]. Standard vessels available with CRN (Canadian Registration General Specifications.

Conforms to the latest edition of ASAME Bulse for Construction of Prevaue Vessels, Section VIII, Division 1.

Compiles with NEPA SB.

TGIC polyester or primed with liquid epoxy and coated with liquid

SCALE: AS NOTED DATE: 10/02/15 DRAWING NO.: DRAWN BY: JM CHECKED BY: PC GENERATOR SPECIFICATIONS SITE ADDRESS: 156 CEDAR GROVE LANE SOMERSET, NJ 08873 SOMERSET COUNTY SDG PROJECT #: 15VNJ015 **Z14** DRAWING TITLE: PAGE NO .: 14 of 23



TOTAL IMPERVIOUS AREA

PAGE NO .: 15 of 23

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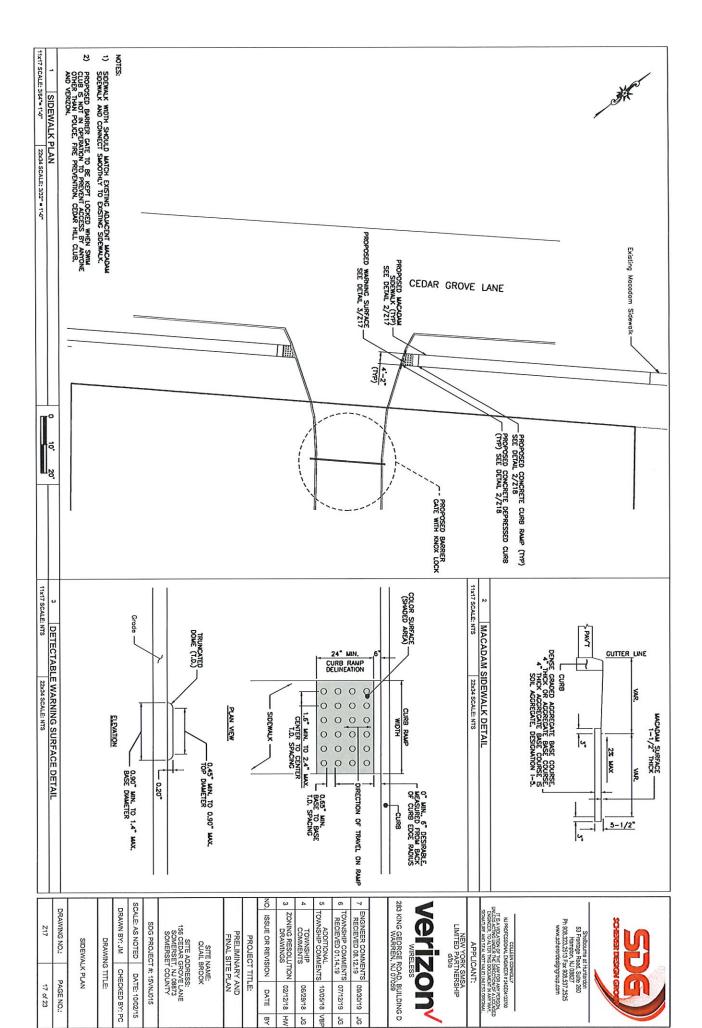
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SITE NAME: QUAIL BROOK

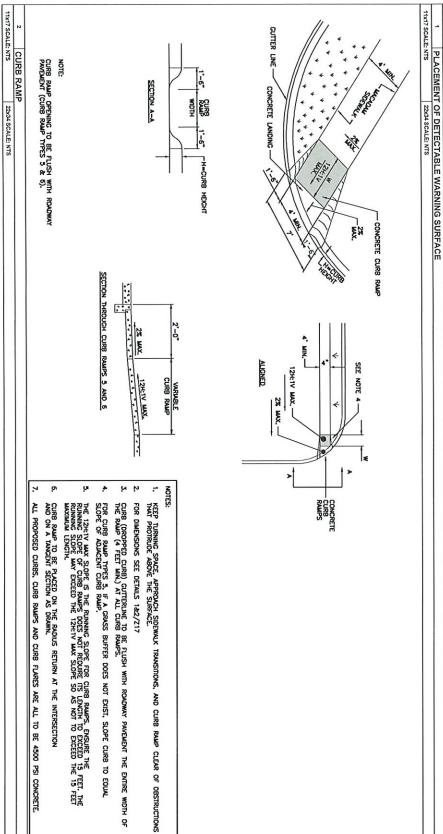


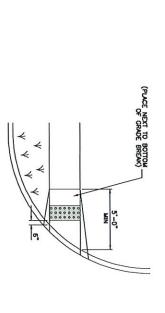
New John St. 1255 New John St.	Shelbourne at Hunterdon 53 Frontage Road, Sulte 260 Hammion, N.I. 08827		
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1 IMPERVIOUS AREA OF PROPOSED VERIZON IMPROVEMENTS/REMEDIATION 0 60 120' 120' 120' 120' 120' 120' 120' 120	T REVIEW EXEMPT OR COMMISSION ZO NON-IMPERVIOUS	TOTAL IMPERVIOUS AREA PRIOR TO REMEDIATION = TOTAL CURRENT IMPERVIOUS AREA (204,572 SF) + IMPERVIOUS AREA OF PROPOSED VERIZON IMPROVEMENTS (8,738 SF) = 213,410 SF	2 / /	FOR STABILIZATION NOTES DETAIL 4/210	IMPERMOUS AREA TO BE REMOVED AND STABILIZED. CONTRACTOR SHALL NOT REMOVE MARE IMPERMOUS SURPACE THAN IS POSSIBLE TO STABILIZE WITHIN A CIVEN WASK SHIFT	IMPERVIOUS AREA PROPOSED TO BE REMOVED FOR DARK COMMISSION ZONE B MINURR DEVELOPMENT REVIEW EXEMPTION AREA # AREA (SF) STRUCTURE TYPE 4 2.627 Removed Turnaround 5 15.583 Parking to be Removed 6 9.762 Parking to be Removed 27,972 Total	TOTAL IMPERVIOUS AREA ASSOCIATED WITH VERIZON IMPROVEMENTS AREA # IAREA (SF) STRUCTURE TYPE 1 1.500 Proposed Compound 2 1.570 Proposed Officeway 3 3.822 Proposed Turnaround 7 749 Proposed Forking Extension 8,738 Total
Z16 16 of 23	— [장면장 중	SDG PROJECT #: 15VNJ015 SCALE: AS NOTED DATE: 10/02/15 DRAWN BY: JM CHECKED BY: PC	PROJECT TITLE: PRELIMINARY AND FINAL SITE PLAN SITE NAME: QUAL BROOK SITE ADDRESS: 156 CEDAR GROVE LAYE SOMERSET, XU 08873 SOMERSET COUNTY	TOWNSHIP COMMENTS 07/12/19 JG	WERELESS 283 KING GEORGE ROAD, BUILDING D WARREN, NJ 07059 7 ENGINEER COMMENTS 09/30/19 JG 7 RECEIVED 08.12.19	UPROFESSION LINEARY SEEMIZE UPROFESSION LINEARY SEEMIZE UNLESS AT SIGNIFICATION OF THE SOCIALITY AND THE SOCIALITY APPLICANT: APPLICANT: APPLICANT: LINEARY YORK SINSA LINEARY SEEMIZE SHIP d/b/a	Sheberr beson engine some state of the state



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IF A CURB RAMP IS REQUIRED. THE LOCATION OF THE DETECTABLE WARNING SURFACE MUST BE AT THE BOTTOM OF THE RAMP AND WITHIN THE REQUIRED DISTANCE FROM THE CURB.

NOTES:

KEEP TURNING SPACE. APPROACH SIDEWALK TRANSITIONS, AND CURB RAMP CLEAR OF OBSTRUCTIONS THAT PROTRUDE ABOVE THE SURFACE.

Shebourne at Hurlardon Shebourne at Hurlardon St Frontage Road, Suite 260 St Humpton, 14, 10827 Ph 988 223.2515 if w. 908.527.2625 www.schorerdealgngroup.com
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SITE NAME:	PRELIMINARY AND FINAL SITE PLAN	PROJECT TITLE:	ISSUE OR REVISION	ZONING RESOLUTION DRAWINGS	TOWNSHIP	ADDITIONAL TOWNSHIP COMMENTS	TOWNSHIP COMMENTS RECIEVED 01.14.19	ENGINEER COMMENTS RECIEVED 08.12.19	
	AND	μ	DATE	02/12/18 HW	06/29/18	10/05/18 VBP	07/12/19 JG	09/30/19 JG	
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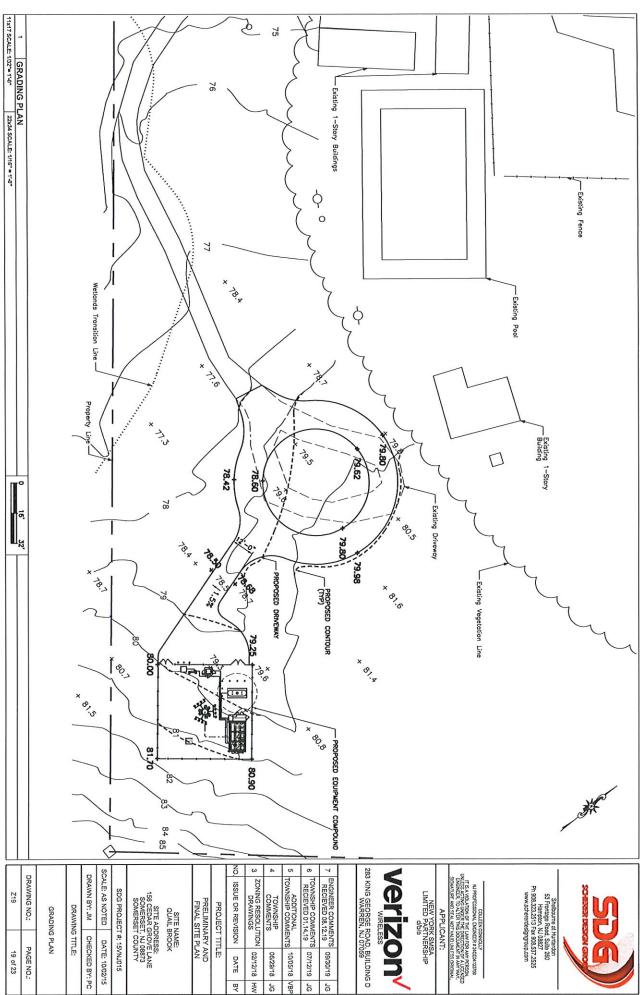
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NEW YORK SMSA LIMITED PARTNERSHIP d/b/a

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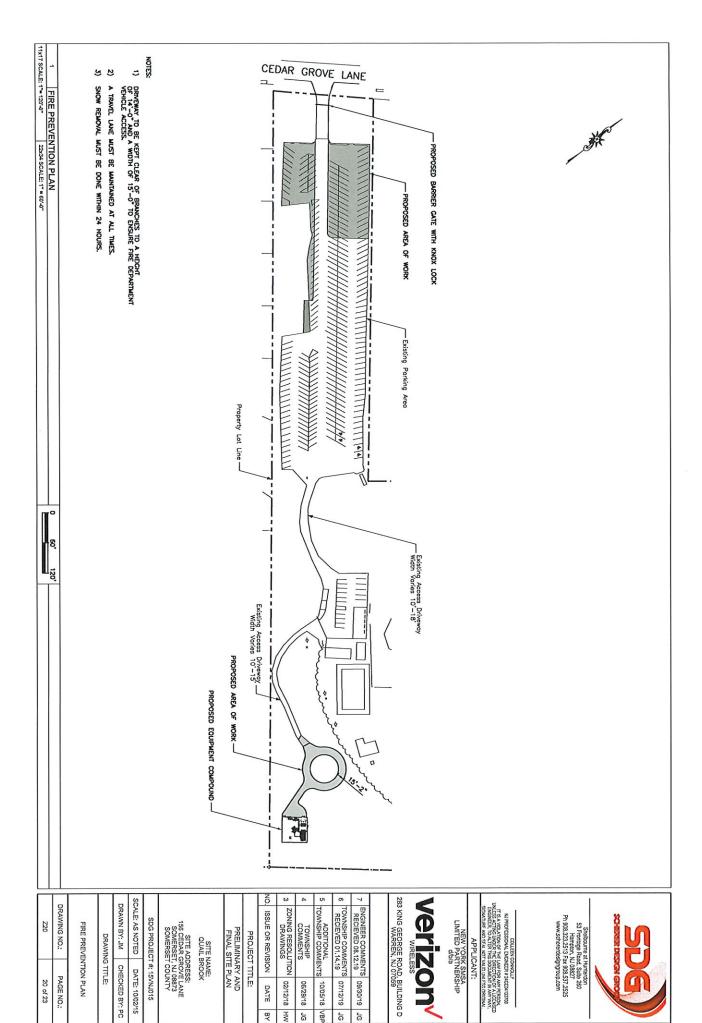
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	Z18	DRAWING NO.:	SIDEWALK DETAILS	DRAWING	DRAWN BY: JM	SCALE: AS NOTED	SDG PROJECT	SITE ADDRESS: 156 CEDAR GROVE LAND SOMERSET, NJ 08873 SOMERSET COUNTY	SITE I	PRELIMINARY FINAL SITE P	PROJEC	ISSUE OR REVISION	ZONING RESOLU DRAWINGS	TOWNSHIP	ADDITIONAL TOWNSHIP COMMENTS	RECIEVED 01.14.19
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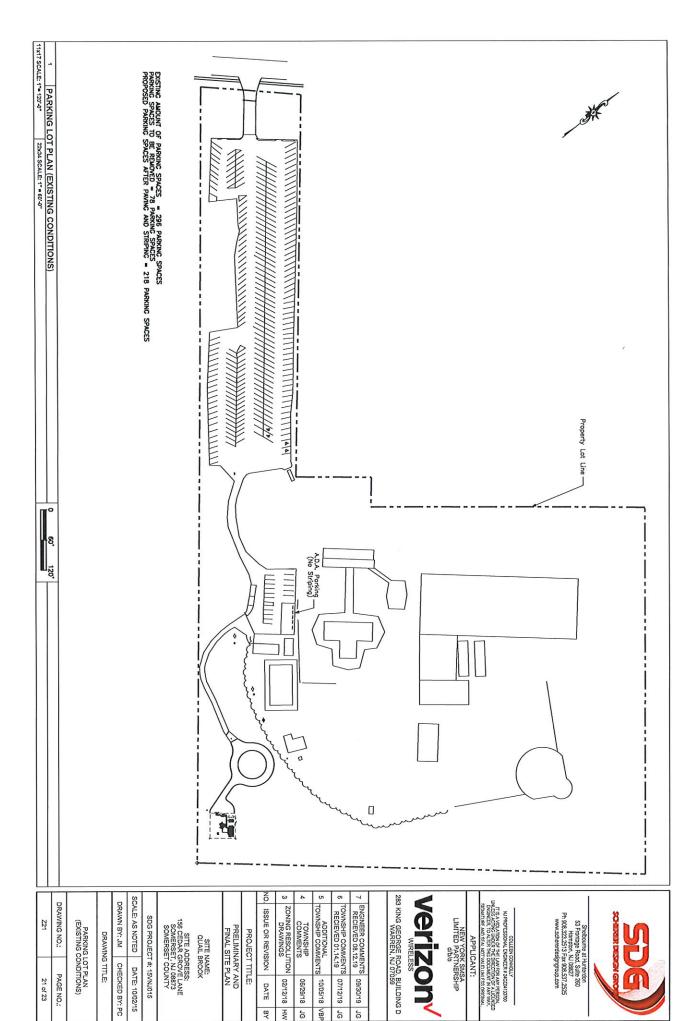
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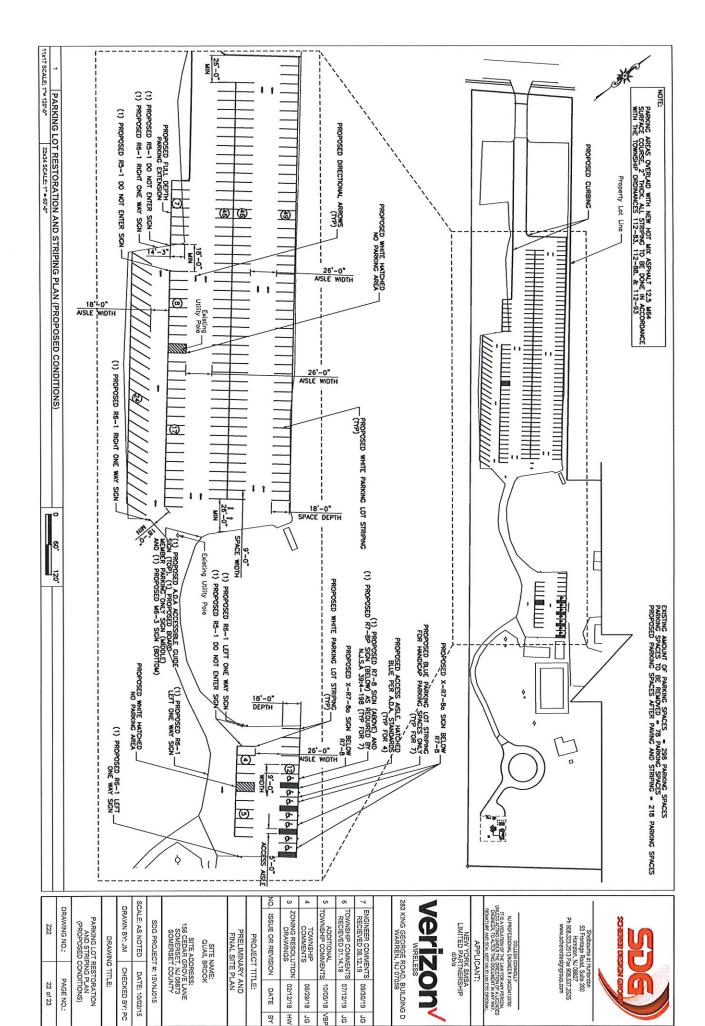


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