

REV:	COMMENT	DATE
0	FOR ZONING BOARD APPROVAL	300CT20

PRELIMINARY AND FINAL SITE PLAN APPLICATION

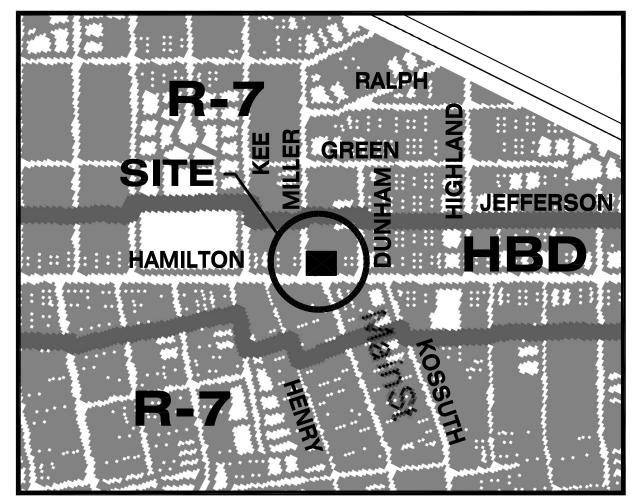

ZONING/KEY MAP SCALE: 1" = 400'

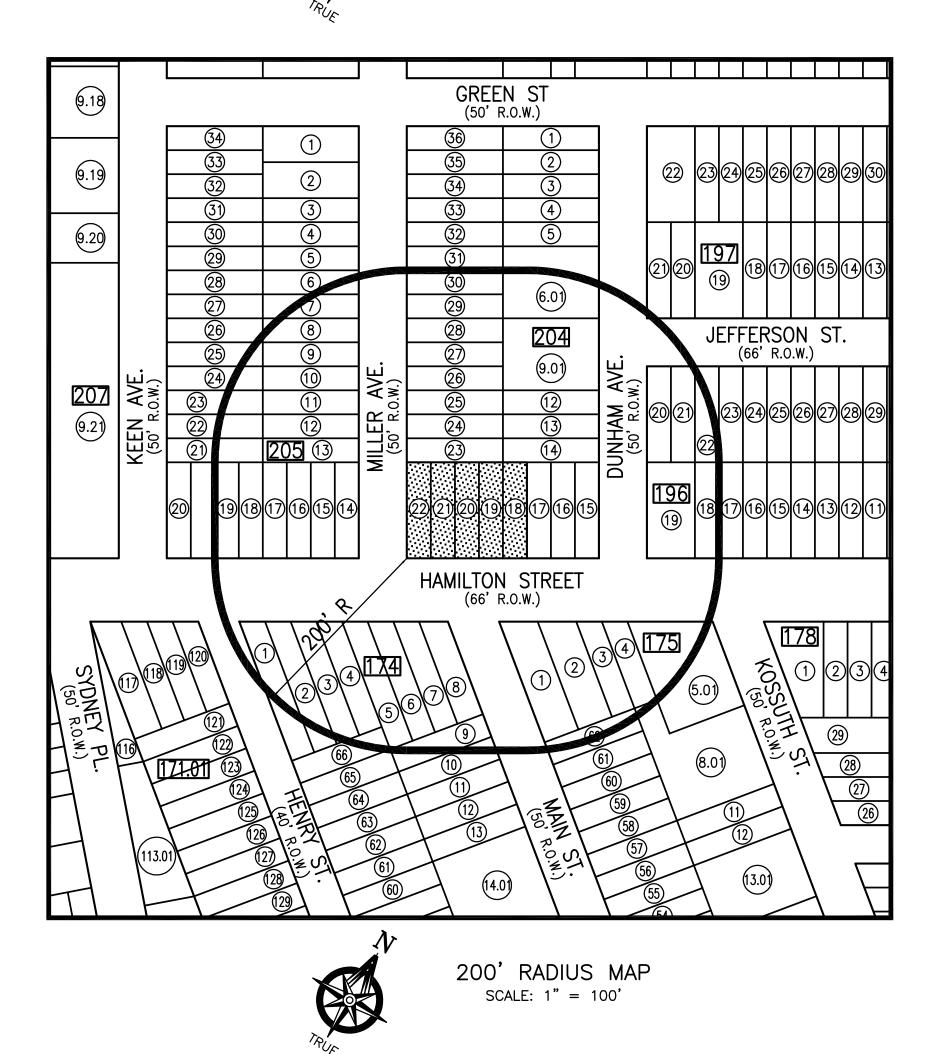

LOCATED AT 587 HAMILTON STREET BLOCK 204, LOTS 18-22 TOWNSHIP OF FRANKLIN COUNTY OF SOMERSET

APPLICANT/OWNER HAMILTON STREET DEVELOPMENT, LLC **587 HAMILTON STREET** SOMERSET, NJ 08873

Ronald J. Sadowski, P.E.

10 EDWARD AVENUE **EDISON, N.J. 08820** (732)-744-6392 ronsadowski@verizon.net

BLOCK: 204 LOTS 18-22 ZONE: HBD HAMILTON STREET BUSINESS DISTRICT TOWNSHIP OF FRANKLIN, NEW JERSEY SCHEDULE OF AREA, YARD, AND BUILDING REQUIREMENTS

		REQUIRED	PROPOSED LOT
MINIMUM LOT AREA (SQ.F	г.)	10,000	12,500
MINIMUM LOT FRONTAGE ((FEET)	100	100
MINIMUM SETBACKS (FEET)		
MAIN STRUCTURE			
	MINIMUM FRONT YARD (FEET)	0	
	HAMILTON ST. (FEET)		0
	MILLER AVE. (FEET)		0
	MINIMUM 1 SIDE YARD (FEET)	5	5.0
	MINIMUM 2 SIDE YARD (FEET)	15	75.0
	MINIMUM REAR YARD (FEET)	20	N.A.
	MAX. BLDG. HEIGHT (STORIES)	3	3
	MAX. BLDG. HEIGHT (FEET)	40	36.55
ACCESSORY BUILDINGS			
	MINIMUM REAR YARD (FEET)	5	N.A.
	MINIMUM SIDE YARD (FEET)	5	N.A.
MAXIMUM BUILDING COVER	RAGE (%)	40	28.3
TOTAL IMPERVIOUS COVER	AGE (%)	85	81.1
NOTE: TOTAL IMPERVIOUS	COVER = 10.140 S0 FT = 0.2	3 AC	_

NOTE: TOTAL IMPERVIOUS COVER = 10,140 SQ.FT. = 0.23 AC.

INDEX OF DRAWINGS (PROJECT S20200)

- **COVER SHEET**
- **GENERAL CONSTRUCTION NOTES**
- **DEMOLITION PLAN**
- SITE IMPROVEMENT PLAN
- PROPOSED GRADING, DRAINAGE & UTILITY PLAN
- PROPOSED LIGHTING PLAN
- PROPOSED LANDSCAPING PLAN
- **DRAINAGE SYSTEM PLAN AND SECTION HBD STREETSCAPE CONSTRUCTION DETAILS**
- HBD STREETSCAPE CONSTRUCTION DETAILS AND SANITARY SEWER PROFILES
- SITE PLAN CONSTRUCTION DETAILS
- SITE PLAN CONSTRUCTION DETAILS SITE PLAN CONSTRUCTION DETAILS
- SITE PLAN CONSTRUCTION DETAILS
- **SOIL EROSION & SEDIMENT CONTROL PLAN & DETAILS**
- **SOIL EROSION & SEDIMENT CONTROL NOTES & DETAILS**
- **SOIL EROSION & SEDIMENT CONTROL NOTES & DETAILS**
- **SOIL EROSION & SEDIMENT CONTROL NOTES & DETAILS**

200 FOOT PROPERTY OWNERS LIST

BLOCK	LOT	NAME/ADDRESS	BLOCK	LOT	NAME/ADDRESS	BLOCK	LOT	NAME/ADDRESS
174	3,4,5,6, 7,8,9	586 HAMILTON STREET, LLC P.O. BOX 467 DAYTON, NJ 08810	196	17,18	KHADDASH, IBRAHIM SALEH 39 CAREY ARTHUR DR WAYNE, NJ 07470	204	19,20, 21,22	587 HAMILTON STREET, LLC 587 HAMILTON STREET SOMERSET, NJ 08873
174	10	EECN, LLC 130 MAIN STREET SOMERSET, NJ 08873	196	19	RAMOS, JUAN R & XIOMARA 575 HAMILTON ST SOMERSET, NJ 08873	204	23,24	HASSAN, MOHAMMAD E. & BEBE FRISHT, 11 MILLER AVE. SOMERSET, NJ 08873
175	1	77 ALEXANDRIA, LLC P.O. BOX 1995 NEW BRUNSWICK, NJ 08903	196	20,21, 22,23	CANNING, MAUREEN 180 JEFFERON ST SOMERSET, NJ 08873	204	25,26, 27,28	
175	2,3,4	GODFREY, AHMAD & URIEKE BROWNIE 578 HAMILTON STREET SOMERSET, NJ 08873	197	21	GANTT, ROBERT 21 DUNHAM AVE SOMERSET, NJ 08873	204	29,30	LEE, HENRY KEH & HELEN L.M., TRUSTI 23 MILLER AVENUE SOMERSET, NJ 08873
175	5.01	UNITED PRODUCTS INC, P.O. BOX 1482 NEW BRUNWICK, NJ 08903	204	6.01	NATAL, LUIS & MARIA COLON 26 DUNHAM AVE SOMERSET, NJ 08873	205	8	GALVAN, OSCAR & MAYRA M 22 MILLER AVE. SOMERSET, NJ 08873
175	8.01	DAUBON, QUIGLEN & ELUENA 130 KOSSUTH ST SOMERSET, NJ 08873	204	9.01	NILESKI, BETTY 18 DUNHAM AVE SOMERSET, NJ 08873	205	9,10, 11	ROMITO, STEPHEN W 9 VERONICA AVE. SOMERSET, NJ 08873
175	62	ZUBAIRU, AHMED 123 MAIN STREET SOMERSET, NJ 08873	204	12,13	FIGUEROA, AUREO L 14 DUNHAM AVE SOMERSET, NJ 08873	205	12,13	RIVERA, JOSEPH 10 MILLER AVE. SOMERSET, NJ 08873
			204	14,15, 16,17	577 SOMERSET, LLC 71 SUTTON RD. CALIFON, NJ 07830	205	14,15	WALTON, VENNISE 593 HAMILTON ST. SOMERSET, NJ 08873

THE FOLLOWING UTILITIES MUST ALSO BE NOTIFIED:

RIGHT-OF-WAY DEPARTMENT BUCKEYE PIPE LINE COMPANY P.O. BOX 368 EMMAUS, PA 18049-0368 BUSINESS MANAGER COMCAST CABLE 279 AMWELL ROAD HILLSBOROUGH, NJ 088

FRANKLIN TOWNSHIP SEWERAGE AUTHORITY 70 COMMERCE AVE. SOMERSET, NJ 08873 SINKING SPRING, PA 19608

FRANKLIN TOWNSHIP SEWERAGE AUTHORITY 70 COMMERCE AVE. SOMERSET, NJ 08873

APPROVED BY THE FRANKLIN TOWNSHIP ZONING

BOARD AS A SITE PLAN:


SECRETARY

TOWNSHIP ENGINEER

SOMERSET COUNTY ACCEPTANCE STAMP

> FOR CONSTRUCTION UNLESS THIS BLOCK IS STAMPED "ACCEPTED AS SUBMITTED" BY A STAFF MEMBER OF THE SOMERSET COUNTY ENGINEERING DIVISION. BIDS FOR CONSTRUCTION SHOULD NOT BE BASED ON THESE PLANS UNTIL THE PLANS ARE ACCEPTED BY

ACCEPTANCE OF THESE PLANS EXPIRES TWO (2) YEARS FROM THE STAMPED DATE.

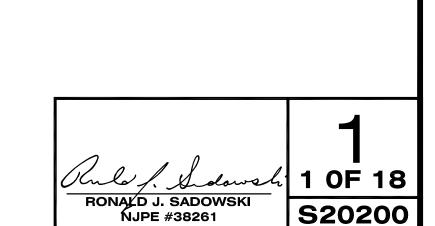

	BALANC	REFERENCES E OF SITE PLAN DRAWINGS.	
	REV 0	REVISION DESCRIPTION FOR ZONING BOARD APPROVAL.	DATE 300CT20
PROJECTED DAILY DEMAND/CONSUMPTION: 1. SANITARY FLOW: NJAC 7:14A PROJECTED FLOW			

GENERAL CONSTRUCTION NOTES

- 1. OWNER/APPLICANT: HAMILTON STREET DEVELOPMENT, LLC C/O FRED HANIKEN 587 HAMILTON STREET SOMERSET, NJ 08873
- 2. LOCATION: BLOCK 204 LOTS 18-22 587 HAMILTON STREET
- 3. ZONING: HBD- HAMILTON BUSINESS DISTRICT
- 4. EXISTING USE: HBD VACANT LAND
- 5. PROPOSED USE: HBD MIXED-USE (COMMERCIAL/RESIDENTIAL)
- 6. PARKING
- ON-SITE REQUIRED = 17 SPACES
- A. RESIDENTIAL = (7) 1-BEDROOM APARTMENTS @ 1.8 SPACES PER = 13 SPACES (2) 2-BEDROOM APARTMENTS @ 2.0 SPACES PER = 4 SPACES
- 7. BOUNDARY AND TOPOGRAPHIC SURVEY OF PROPERTY DATED AUGUST 20, 2020, PREPARED BY BRAGINSKY SURVEYING, LLC, 2 AUSTIN AVENUE, ISELIN, NJ 08830.
- 8. THE PROPOSED DEVELOPMENT IS TO BE SERVICED BY PUBLIC SANITARY SEWER AND
- 9. PER FEMA FLOOD INSURANCE RATE MAPS (FIRM) THE PROJECT SITE IS LOCATED
- IN ZONE "X", AREA OF MINIMAL FLOODING.
- 10. PER USDA SOIL SURVEY MAP THE SITE SOIL IS "KkoC" KLINESVILLE WITH A HYDOLOGIC SOIL GROUP "D".
- 11. WATERLINE AND SANITARY SEWER LATERALS TO BE A MINIMUM 10 FEET APART HORIZONTALLY AND 18 INCHES VERTICALLY UNLESS OTHERWISE NOTED.
- 12. ALL CONSTRUCTION SHALL BE IN ACCORDANCE WITH THE APPLICABLE AUTHORITY INCLUDING BUT NOT LIMITED TO, SOMERSET COUNTY RULES AND REGULATIONS, THE FRANKLIN TOWNSHIP LAND USE ORDINANCE, AND STATE APPROVING AGENCIES.
- 13. THE CONTRACT DRAWINGS INDICATE THE APPROXIMATE LOCATION OF EXISTING SUBSURFACE UTILITIES IN THE VICINITY OF THE DEVELOPMENT AND ARE NOT GUARANTEED FOR ACCURACY AND OR COMPLETENESS. THE CONTRACTOR SHALL VERIFY DEPTH AND LOCATION OF ALL EXISTING UTILITIES PRIOR TO CONSTRUCTION (1-800-272-1000). ANY CONFLICTS WITH PROPOSED CONSTRUCTION ARE TO BE BROUGHT TO THE IMMEDIATE ATTENTION OF THE PROJECT ENGINEER. ALL EXISTING UTILITIES THAT ARE TO BE RELOCATED OR ALTERED IN ANY MANNER ARE TO BE DONE SO IN ACCORDANCE WITH THE RESPECTIVE UTILITY COMPANIES STANDARDS. ALL EXISTING UTILLITIES EXPOSED DURING CONSTRUCTION ARE TO BE SUPPORTED UNTIL BACKFILL IS IN PLACE. ANY CROSSINGS LESS THAN 18 INCHES CLEAR SHALL BE CONCRETE ENCASED.
- 14. DESIGN AND INSTALLATION OF ELECTRIC, GAS, TELEPHONE, AND CABLE TELEVISION ARE TO BE PROVIDED BY THEIR RESPECTIVE UTILITY COMPANIES.
- 15. SITE GRADING AND UTILITY WORK ARE TO BE PERFORMED IN A MANNER TO MINIMIZE DAMAGE TO EXISTING VEGETATION AND TREES. ALL AREAS NOT AFFECTED BY CONSTRUCTION ARE TO REMAIN NATURAL AND UNDISTURBED.
- 16. ALL EXISTING AND PREOJECT-GENERATED DEBRIS IS TO BE REMOVED AND PROPERLY DISPOSED OF IN ACCORDANCE WITH ALL APPLICABLE REGULATIONS.
- 17. TOPSOIL THAT HAS BEEN REMOVED FOR THE GRADING OF THE SITE SHALL NOT BE USED AS SPOIL. THE TOPSOIL SHALL BE REDISTRIBUTED ON GREEN AREAS SO AS TO PROVIDE A MINIMUM OF AT LEAST 6 INCHES OF COVER ON THOSE AREAS.
- 18. COMPACTION IN FILL AREAS BENEATH ALL PROPOSED UTILITIES AND STRUCTURES SHALL MEET ALL MANUFACTURER AND TOWNSHIP REQUIREMENTS.
- 19. ALL GRADING OF LAWN AREAS SHALL BE A MINIMUM OF 2% AND A MAXIMUM OF 12 FEET HORIZONTAL TO 1 FOOT VERTICAL WITHIN 8 FEET OF ALL FOUNDATIONS AND 3 FEET HORIZONTAL TO 1 FOOT VERTICAL IN ALL OTHER AREAS.
- 20. AN AS-BUILT PLAN OF THE ENTIRE DEVELOPMENT, CERTIFIED BY A NEW JERSEY LICENSED LAND SURVEYOR SHALL BE SUBMITTED TO THE TOWNSHIP PRIOR TO RELEASE OF THE PERFORMANCE BOND.
- 21. NO SOIL SHALL BE IMPORTED OR EXPORTED FROM THE SITE UNTIL A SOIL IMPORTATION OR EXPORTATION PERMIT HAS BEEN OBTAINED FROM THE TOWNSHIP AS REQUIRED BY ORDINANCE. SOIL REMOVAL SHALL BE IN ACCORDANCE WITH SECTION 112-8N OF THE LAND USE ORDINANCE.
- 22. THE LOWEST FLOOR ELEVATIONS, INCLUDING RESIDENTIAL BASEMENTS IF PROPOSED, ARE TO BE SET A MINIMUM 2 FEET ABOVE THE SEASONAL HIGH GROUNDWATER ELEVATION.
- 23. ALL UNDERGROUND STORAGE BASIN PIPE JOINTS ARE TO BE GASKETED (WATERTIGHT).
- 24. GROUNDWATER DEPTH WAS FOUND TO BE AT ELEVATION 95.0.
- 25. REFER TO THE SITE GRADING PLAN FOR FINISHED FLOOR ELEVATIONS.
- 26. ALL TRAFFIC CONTROL SIGNS AND MARKINGS SHALL CONFORM WITH CURRENT MUTCD STANDARDS.
- 27. OFFICIAL STREET ADDRESSES SHALL BE OBTAINED FROM THE FRANKLIN TOWNSHIP 911 COORDINATOR.
- 28. SUBMISSION OF AN ENGINEERING COST ESTIMATE WILL BE REQUIRED ONCE FINAL PLANS ARE SIGNED-OFF ON BY THE BOARD. UPON APPROVAL, APPLICANT SHALL PROVIDE APPROPRIATE BONDS AND ENGINEERING INSPECTION FEES AND ATTEND A PRE-CONSTRUCTION MEETING, PRIOR TO THE COMMENCEMENT OF ANY SITE WORK.
- 29. ALL FEES SHALL BE PAID BY THE APPLICANT AT THE TIME OF ADOPTION OF A RESOLUTION OF SITE PLAN APPROVAL FOR THE COST OF MAKING UPGRADES AND MODIFICATIONS TO THE TAX MAPS AND GEOGRAPHIC INFORMATION SYSTEM (GIS) (SECTION 112-329).
- 30. AT THE TIME THAT FINAL PLANS ARE SUBMITTED FOR SIGNATURE BY THE MUNICIPAL OFFICIALS, THE APPLICANT SHALL SUBMIT CAD-GENERATED DATA FILES, PREPARED BY A NEW JERSEY LICENSED LAND SURVEYOR, DIRECTLY TRANSLATABLE INTO AN IDENTICAL IMAGE OF THE PLAN PER THE REQUIREMENTS OF SECTION 112-329.

- PROPOSED CONDITION
 - A. 1 BEDROOM APARTMENT = 150 GPD No. OF UNITS = 7PROJECTED FLOW = $7 \times 150 \text{ GPD} = 1,050 \text{ GPD}$
- B. 2 BEDROOM APARTMENT = 225 GPD No. OF UNITS = 2PROJECTED FLOW = $2 \times 225 \text{ GPD} = 450 \text{ GPD}$

TOTAL PROJECTED AVERAGE FLOW = 1,500 GPD

ESTIMATED PEAK FLOW = $2.5 \times AVG$. = $2.5 \times 1,500 = 3,750 GPD$

2. WATER NJAC 5:21-5 & 7:10-12.6 AVERAGE WATER DEMAND

PROPOSED CONDITION: DOMESTIC DEMAND

- A. 1 BEDROOM APARTMENT = 120 GPD No. OF UNITS = 7PROJECTED DEMAND = $7 \times 120 \text{ GPD} = 840 \text{ GPD}$
- B. 2 BEDROOM APARTMENT = 175 GPD No. OF UNITS = 2PROJECTED DEMAND = $2 \times 175 \text{ GPD} = 350 \text{ GPD}$

TOTAL PROJECTED AVERAGE DEMAND = 1,190 GPD

ESTIMATED PEAK DEMAND = $2.5 \times AVG$. = $2.5 \times 1,190 = 2,975 GPD$

PROPOSED STREET ADDRESSES

BLOCK 204 LOTS 18-22 587 HAMILTON STREET

Owner / Project

PRELIMINARY AND FINAL SITE PLAN APPLICATION 587 HAMILTON STREET BLOCK 204 LOTS 18-22 FRANKLIN TOWNSHIP, NEW JERSEY

RONALD J. SADOWSKI, P.E.


ENGINEERING & CONSTRUCTION MANAGEMENT 10 EDWARD AVENUE EDISON, NEW JERSEY 08820 (732) 744-6392ronsadowski@verizon.net

> GENERAL CONSTRUCTION NOTES

SCALE AS NOTED RJS DATE 01AUG20 CHECKED PROJECT NO. Kuld I. Slowsh

RONALD J. SADOWSKI PROFESSIONAL ENGINEER NJPE #38261

S19010 DRAWING NO.

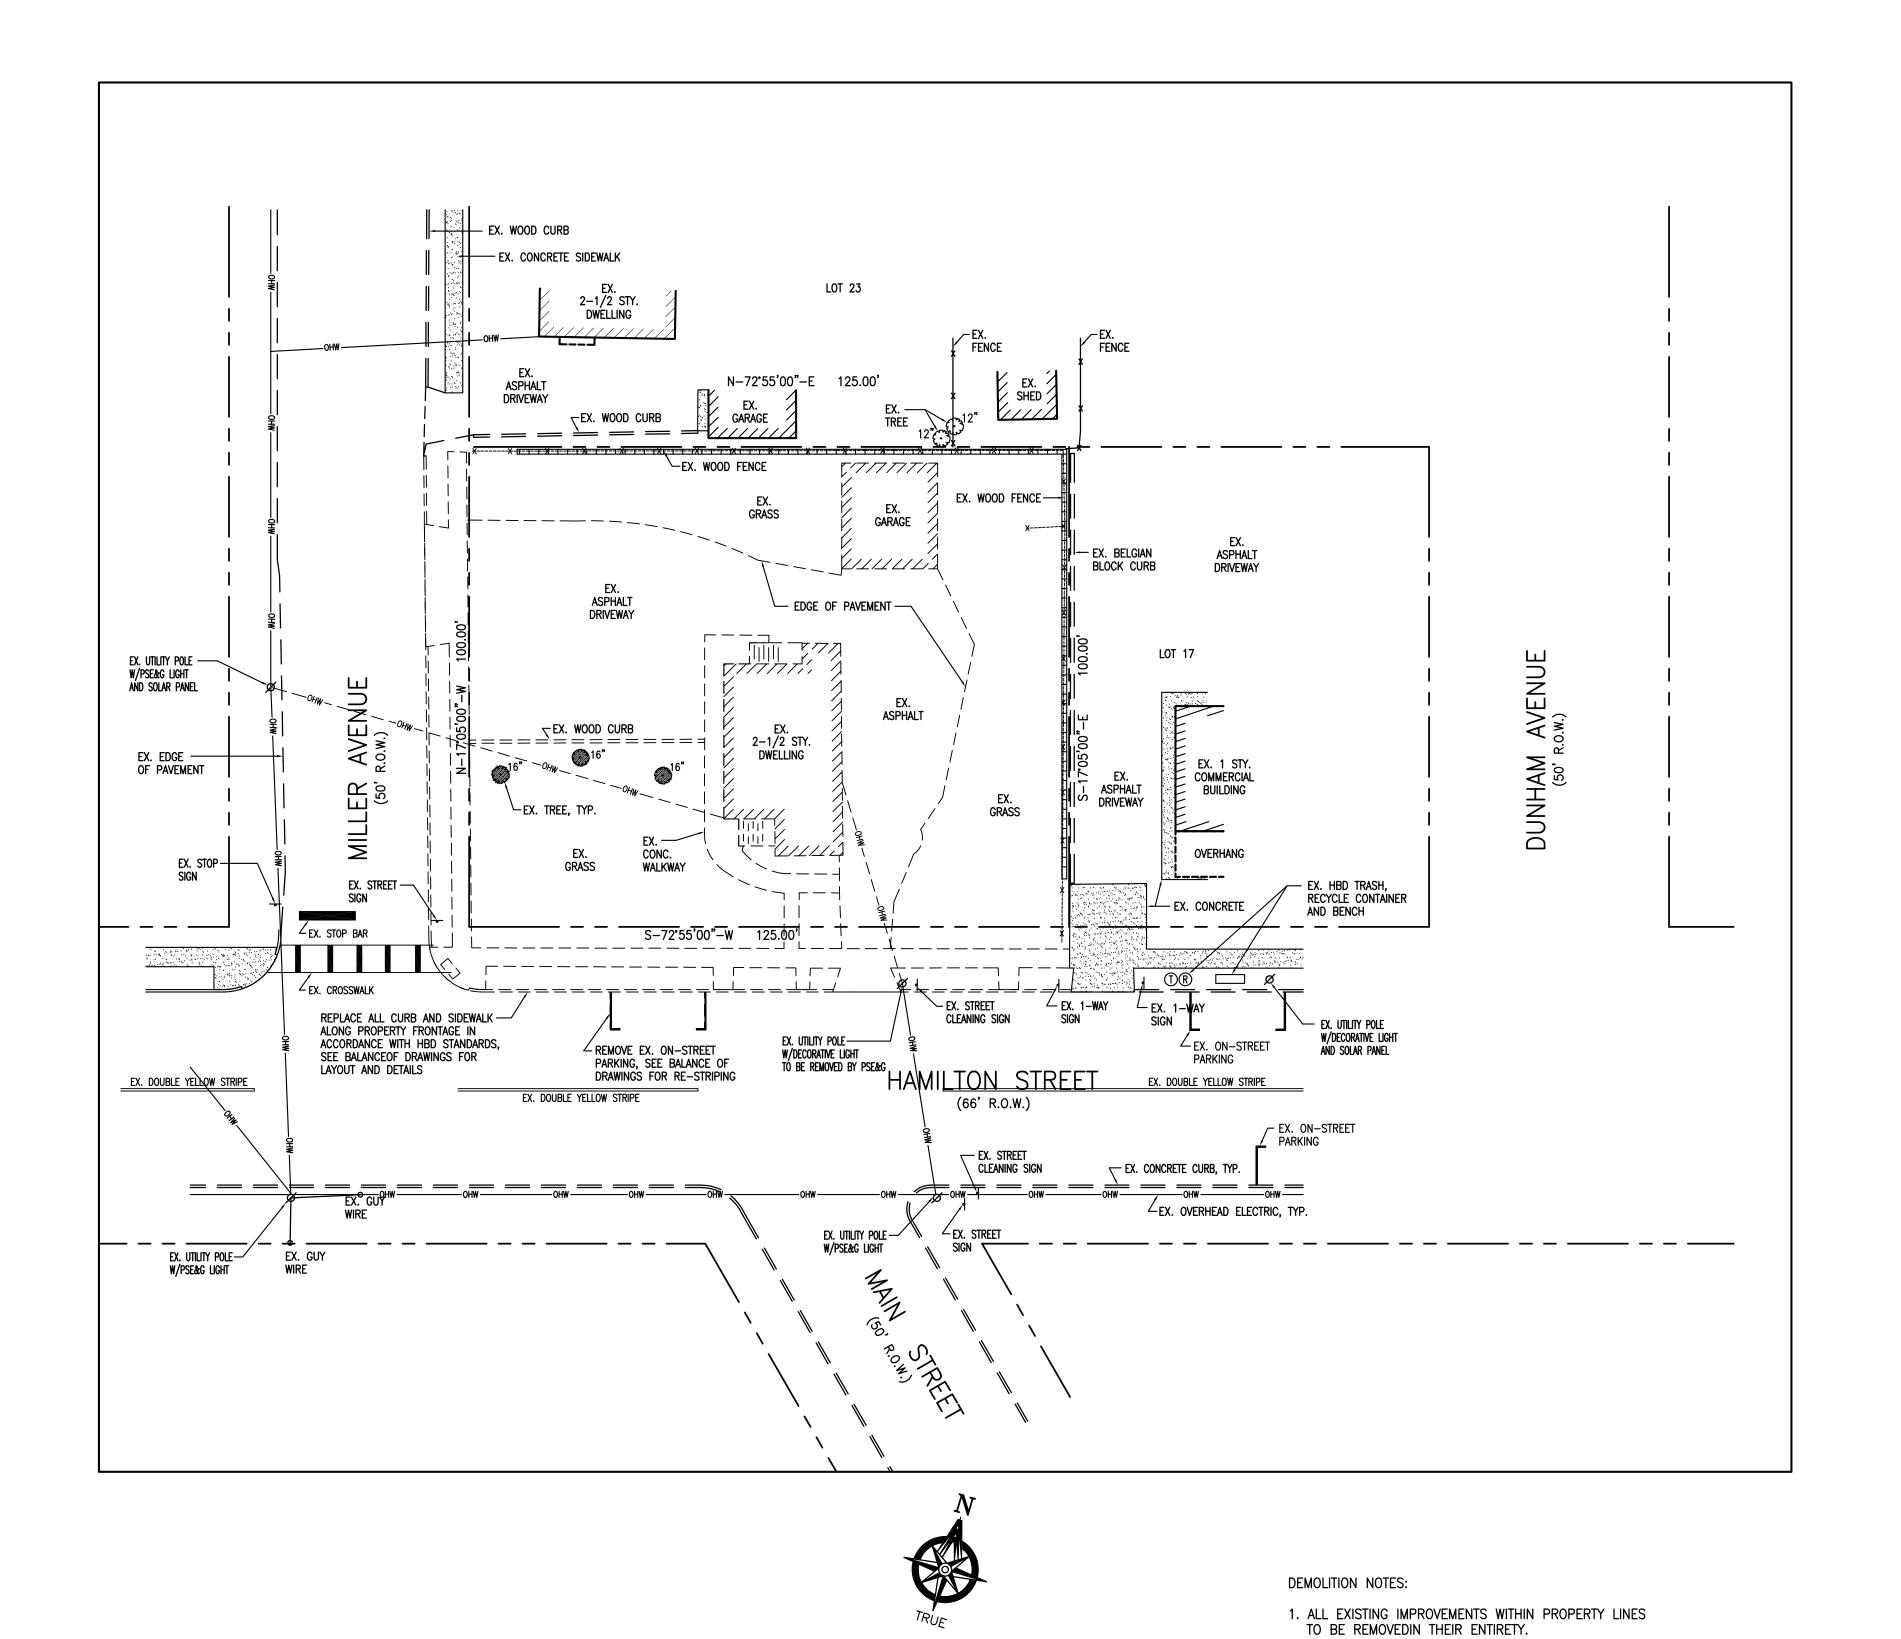

GRAPHIC SCALE : 1" = 20'-0"

REFERENCES

BOUNDARY AND TOPOGRAPHIC SURVEY DATED AUGUST 20, 2020, PREPARED BY BRAGINSKY SURVEYING, LLC, 2 AUSTIN AVENUE, ISLEIN, NJ 08830.

REV REVISION DESCRIPTION DATE

0 FOR ZONING BOARD APPROVAL. 300CT20

Owner / Project

PROTECT YOURSELF a phone call can be your insurance policy

WHAT YOU DON'T KNOW CAN HURT YOU.
THE STATE OF NEW JERSEY REQUIRES NOTIFICATION OF
EXCAVATORS, DESIGNERS, OR ANY PERSON PREPARING TO
DISTURB THE EARTH'S SURFACE ANYWHERE IN THE STATE.

2. ALL EXISTING CURB AND SIDEWALK ALONG PROPERTY

SITEPLAN DRAWINGS FOR LAYOUT AND DETAILS.

RESPECTIVE UTILITY STANDARDS.

FRONTAGE TO BE REMOVED AND REPLACED TO CONFORM WITH TOWNSHIP HBD STANDARDS. REFER TO BALANCE OF

3. ALL EXISTING UTILITIES ON SITETO BE REMOVED TO THEIR RESPECTIVE MAIN SERVICES IN ACCORDANCE WITH THEIR

PRELIMINARY AND FINAL
SITE PLAN APPLICATION
587 HAMILTON STREET
BLOCK 204 LOTS 18-22
FRANKLIN TOWNSHIP, NEW JERSEY


RONALD J. SADOWSKI, P.E.


ENGINEERING & CONSTRUCTION MANAGEMENT

10 EDWARD AVENUE
EDISON, NEW JERSEY 08820
(732) 744-6392
ronsadowski@verizon.net

DEMOLITION PLAN

DRAWN RJS CHECKED RJS	SCALE AS NOTED DATE 01AUG20
Rulo J. S. dowski	PROJECT NO. S20200
RONALD J. SADOWSKI PROFESSIONAL ENGINEER NJPE #38261	DRAWING NO.

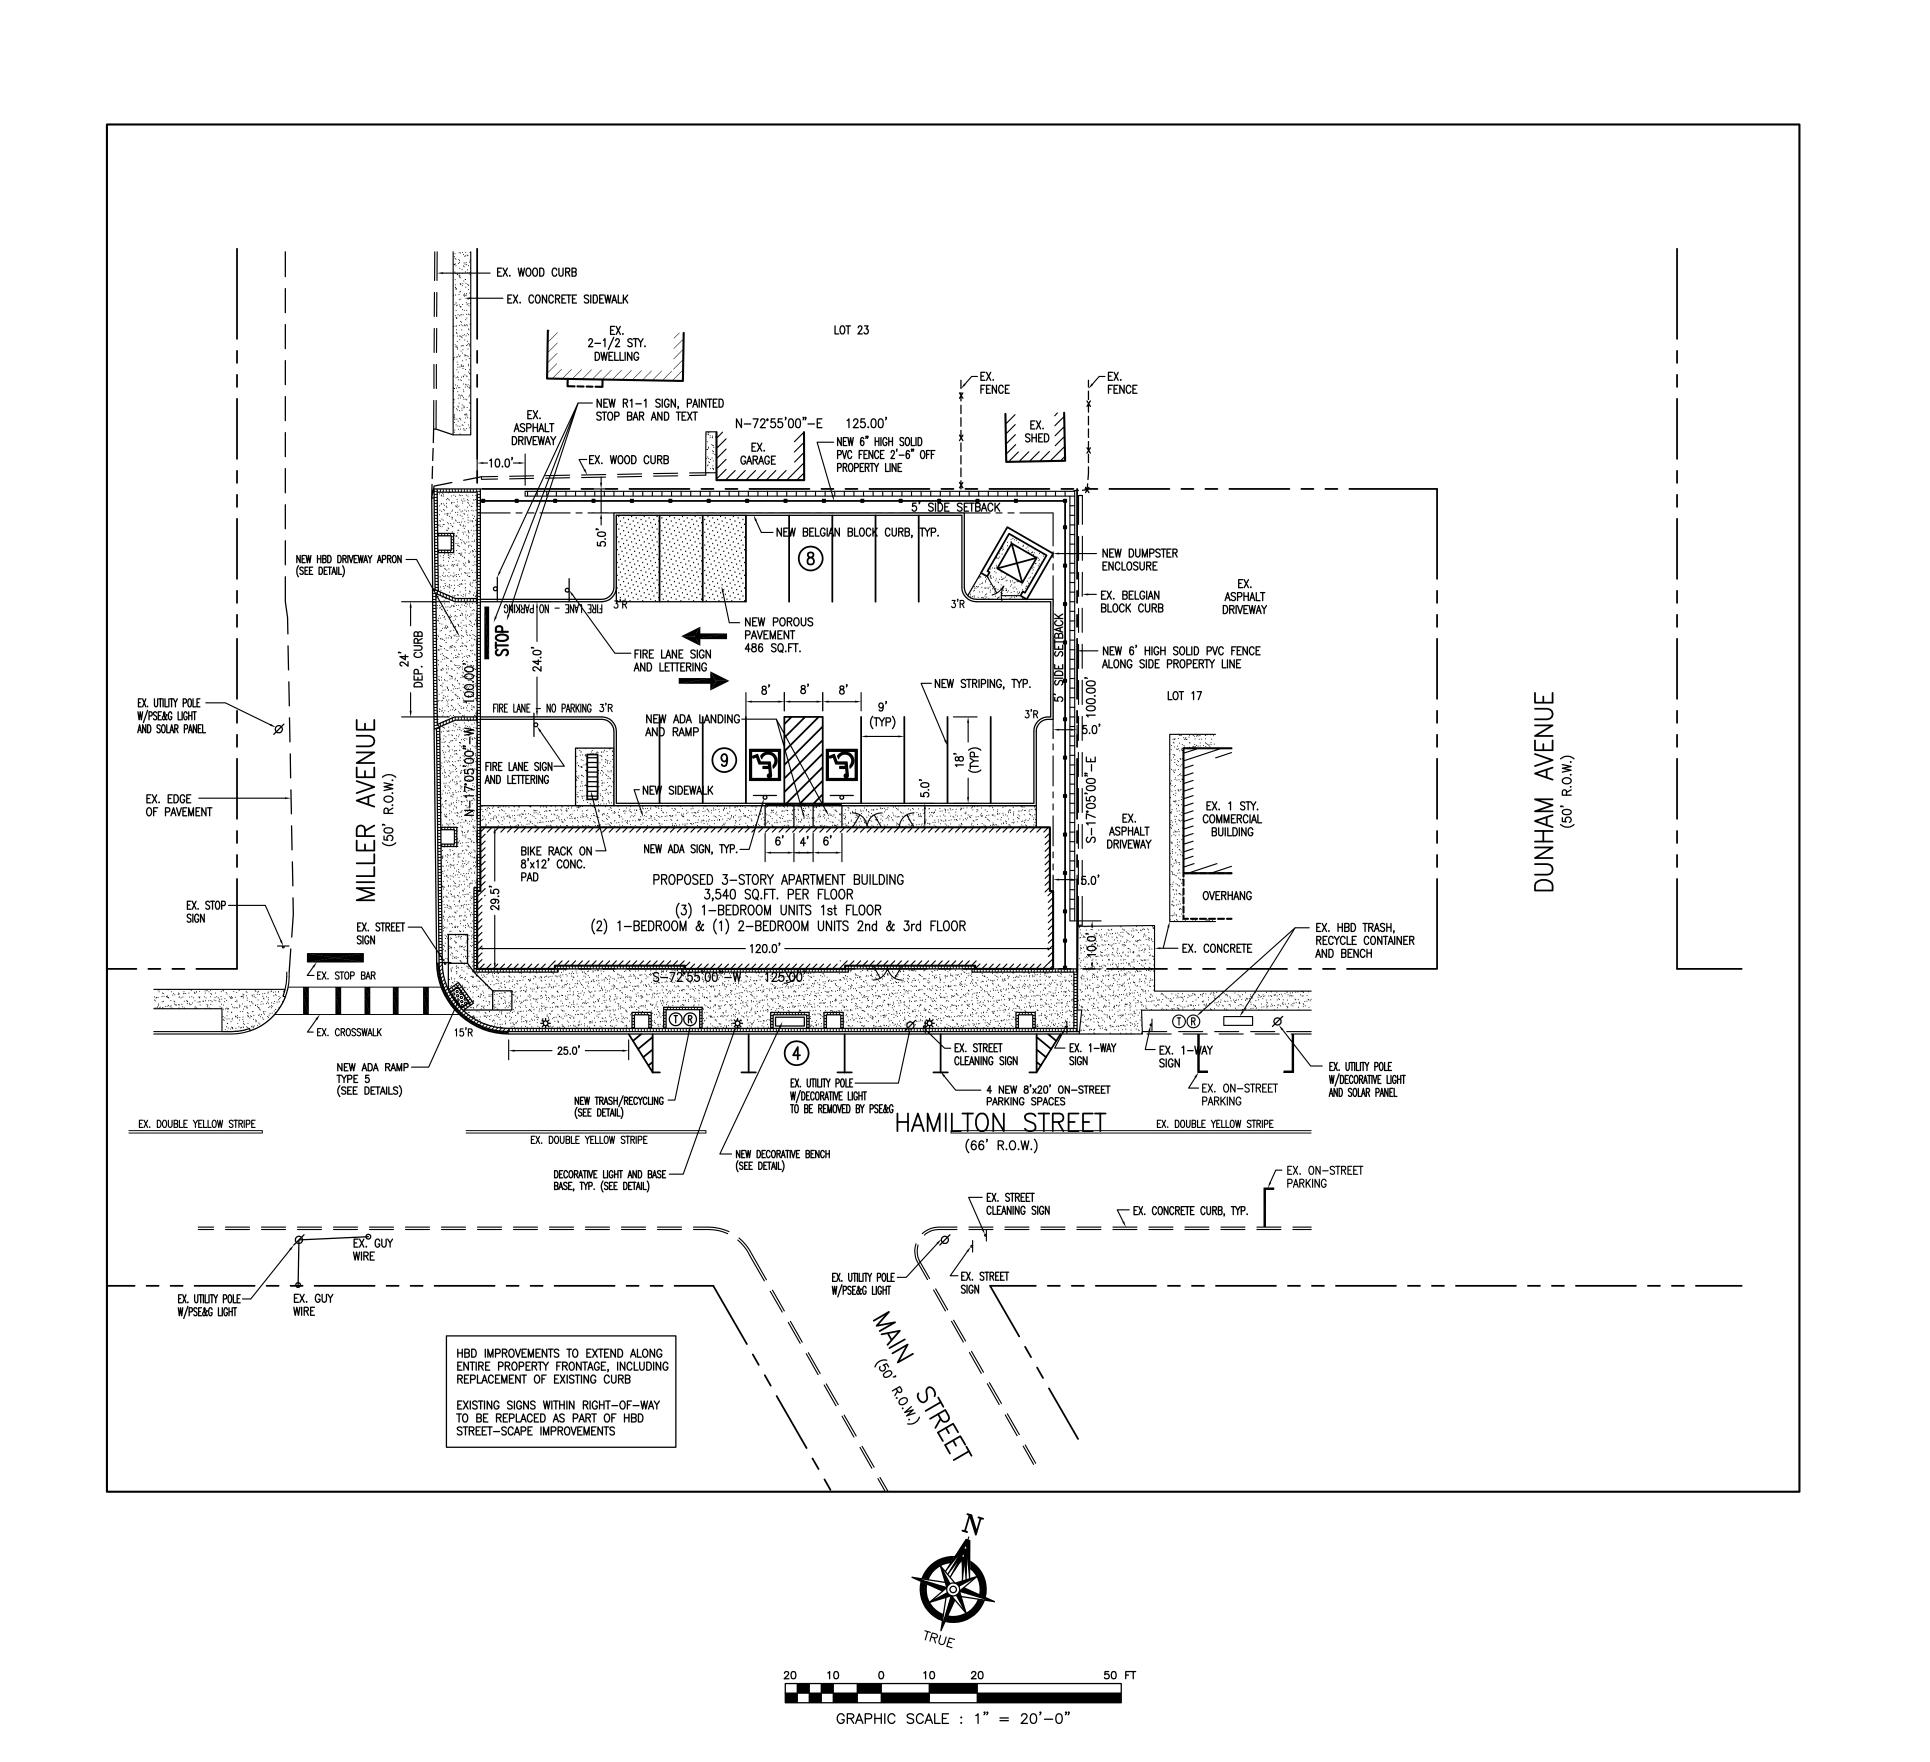

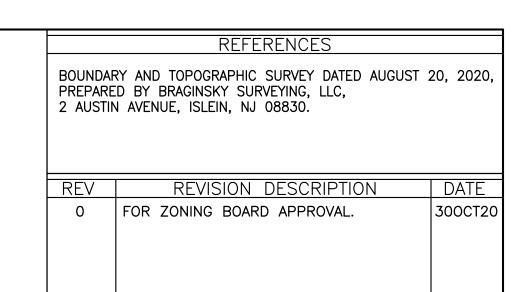

Owner / Project


PRELIMINARY AND FINAL
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587 HAMILTON STREET
BLOCK 204 LOTS 18-22
FRANKLIN TOWNSHIP, NEW JERSEY

RONALD J. SADOWSKI, P.E.


ENGINEERING & CONSTRUCTION MANAGEMENT

10 EDWARD AVENUE
EDISON, NEW JERSEY 08820
(732) 744-6392
ronsadowski@verizon.net

SITE IMPROVEMENT PLAN

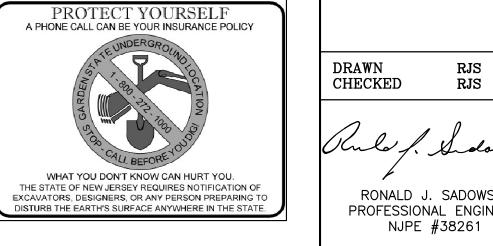

DRAWN RJS CHECKED RJS	SCALE AS NOTED DATE 01AUG20
Rula J. S. dowski	PROJECT NO. S20200
RONALD J. SADOWSKI PROFESSIONAL ENGINEER NJPE #38261	DRAWING NO.

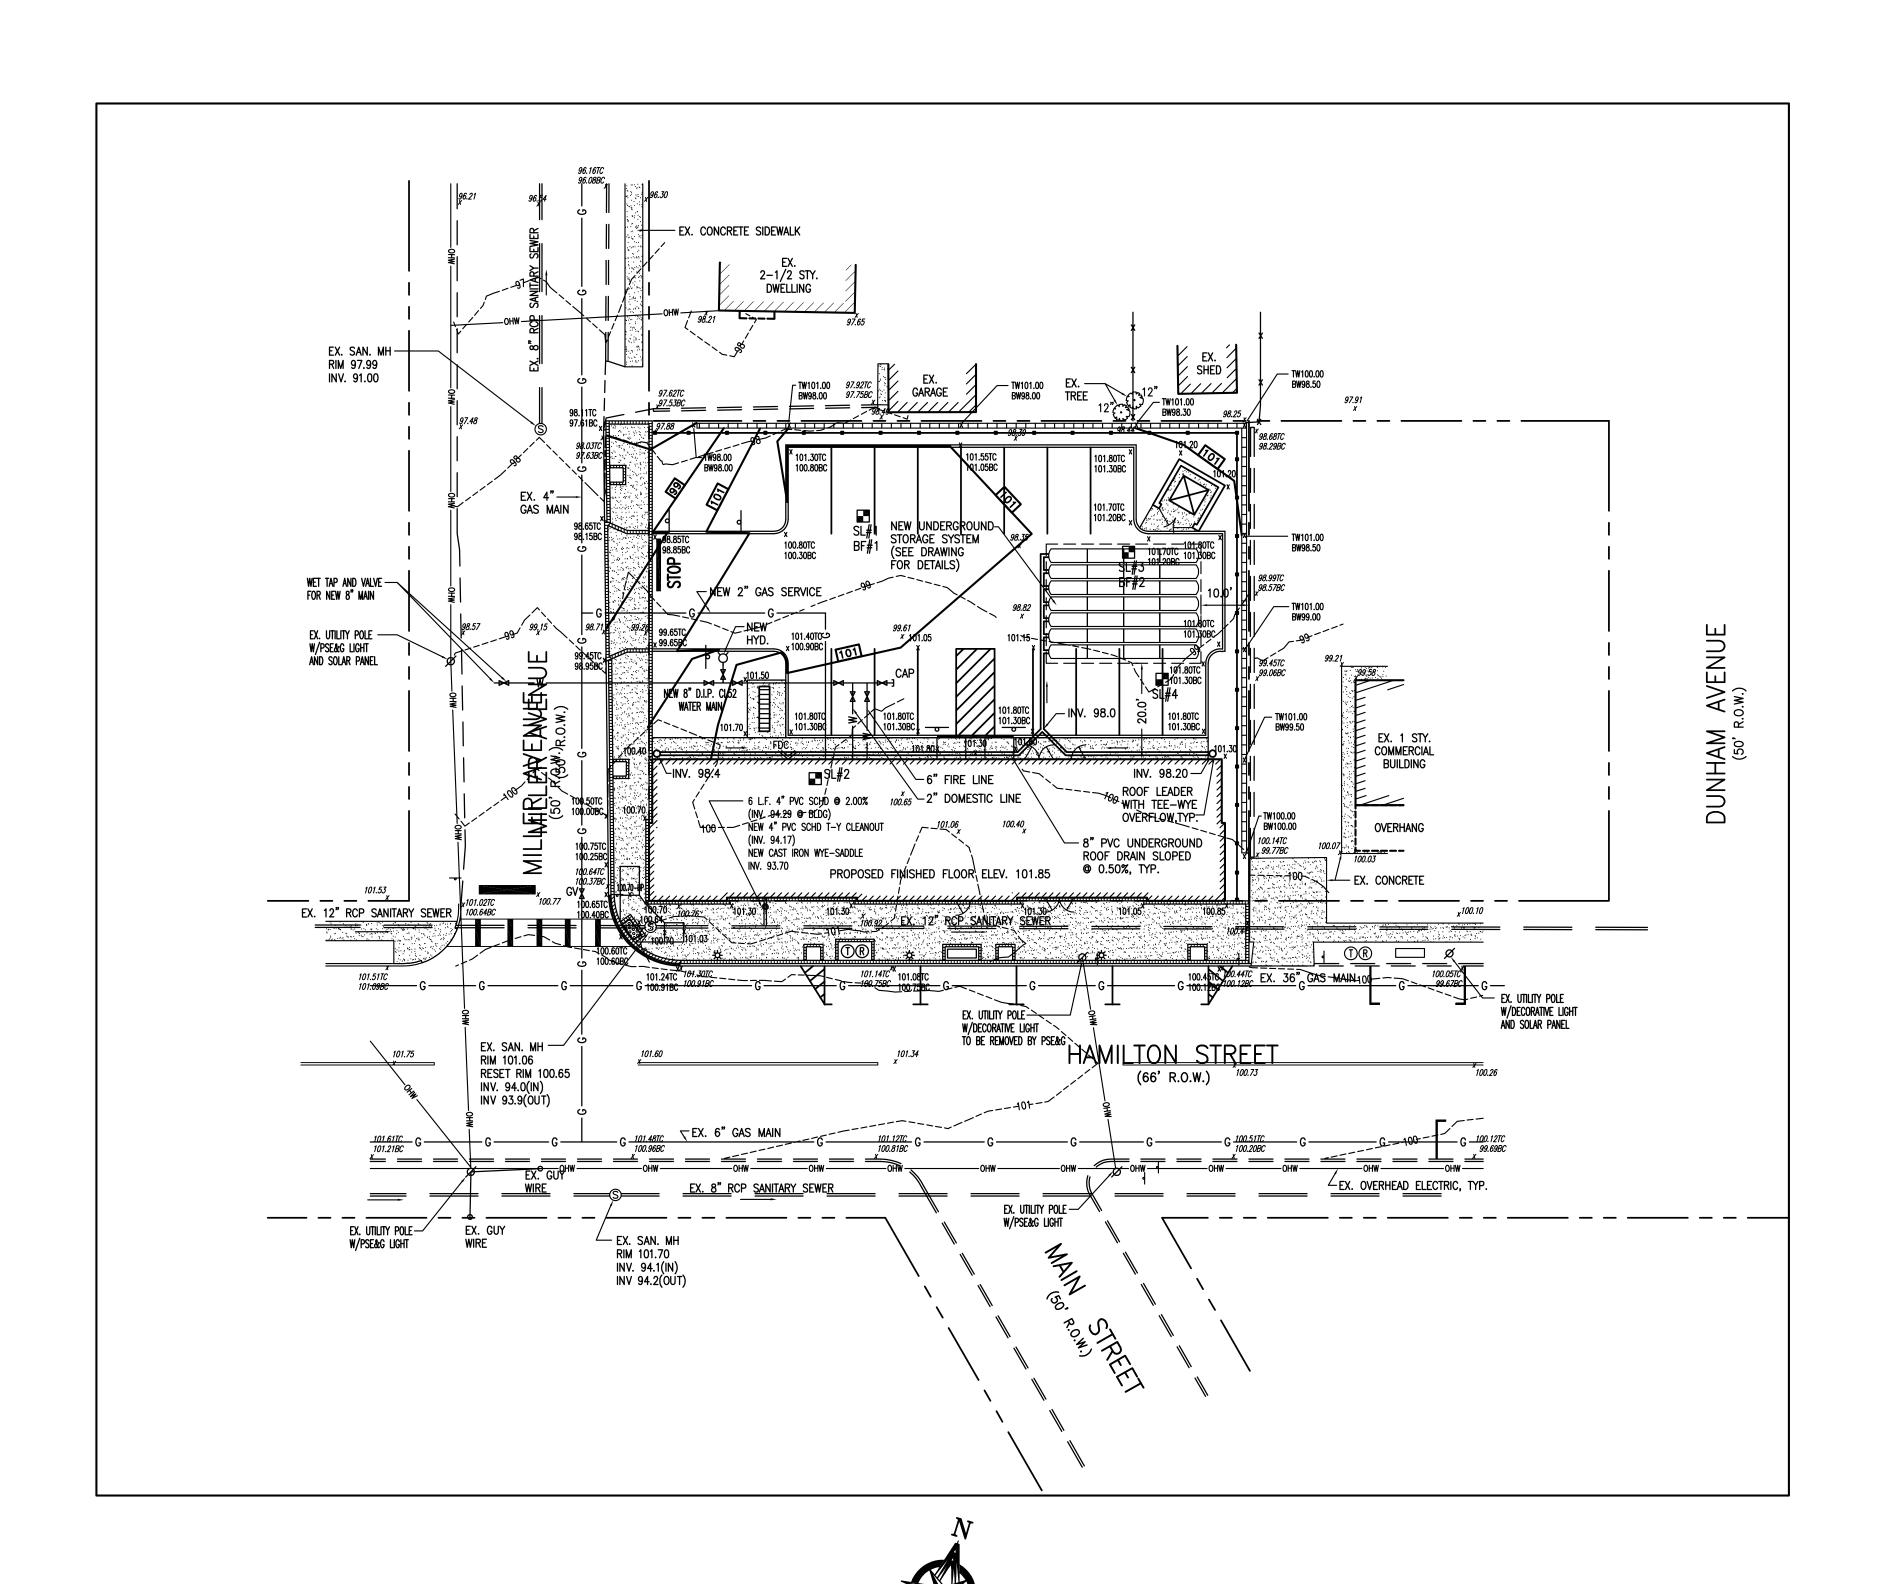

GRAPHIC SCALE : 1" = 20'-0"

BOUNDARY AND TOPOGRAPHIC SURVEY DATED AUGUST 20, 2020, PREPARED BY BRAGINSKY SURVEYING, LLC, 2 AUSTIN AVENUE, ISLEIN, NJ 08830.

REV REVISION DESCRIPTION DATE

FOR ZONING BOARD APPROVAL.

300CT20

REFERENCES

SOIL LOG #1 (SL)/BASIN FLOOD TEST #1 (BF)

Test Date: October 16, 2020

0" - 8" TOPSOIL

" – 16" 10YR5/4 YELLOW BROWN CLAY LOAM, SUBANGULAR BLOCKY, FRIABLE

' - 48" 10YR5/4 DARK YELLOW BROWN FRACTURED ROCK (SHALE), 20% GRAVEL, 40% COBBLES, 30% STONE, WITH 10% CLAY LOAM AS FILLER, SUBANGULAR BLOCKY, FRIABLE, MOTTLING © 36", COMMON MEDIUM, DISTRICT 10YR7/1 NO SEEPAGE

BOTTOM OF TEST PIT @ 3'-0" (36") (MACHINE REFUSAL @ 48")

BASIN FLOODING TEST RESULTS

1st FILLING12" WATER EMPTIED LESS IN 2 HOURS 20 MINUTES2nd FILLING12" WATER EMPTIED LESS IN 3 HOURS 45 MINUTES

RESULT: POSITIVE FRACTURED ROCK SUBSTRATUM

PERMEABILITY RATE OF 0.5 INCH/HOUR

SOIL LOG #2 (SL)

Test Date: October 16, 2020

- 8" TOPSOIL

9" - 16" 10YR5/4 YELLOW BROWN CLAY LOAM, SUBANGULAR BLOCKY, FRIABLE

68" 10YR4/4 DARK YELLOW BROWN FRACTURED ROCK (SHALE), 20% GRAVEL, 40% COBBLES, 30% STONE, 10% CLAY LOAM AS FILLER, SUBANGULAR BLOCKY, FRIABLE

SEEPAGE @ 68", 6" WATER ACCUMULATED IN 4 HOURS (MACHINE REFUSAL @ 68")

SOIL LOG #3 (SL)/BASIN FLOOD TEST #2 (BF)

Test Date: October 26, 2020

- 14" TOPSO

14" - 30" 10YR5/4 YELLOW BROWN CLAY LOAM, SUBANGULAR BLOCKY, FRIABLE

30" - 54" 10YR5/4 DARK YELLOW BROWN FRACTURED ROCK (SHALE), 15% GRAVEL 30% COBBLES, 40% STONE, WITH 15% CLAY LOAM AS FILLER, SUBANGULAR BLOCKY, FRIABLE, MOTTLING @ 42", COMMON MEDIUM, DISTRICT 10YR7/1

BOTTOM OF TEST PIT @ 2'-8" (32") (MACHINE REFUSAL @ 54")

BASIN FLOODING TEST RESULTS

1st FILLING 12" WATER EMPTIED LESS IN 4 HOURS 5 MINUTES
2nd FILLING 12" WATER EMPTIED LESS IN 4 HOURS 0 MINUTES

RESULT: POSITIVE FRACTURED ROCK SUBSTRATUM

PERMEABILITY RATE OF 0.5 INCH/HOUR

SOIL LOG #4 (SL)

Test Date: October 26, 2020

1" - 10" TOPSOIL

10" - 28" 10YR5/4 YELLOW BROWN CLAY LOAM, SUBANGULAR BLOCKY, FRIABLE

50" 10YR4/4 DARK YELLOW BROWN FRACTURED ROCK (SHALE),
 20% GRAVEL, 40% COBBLES, 30% STONE, 10 % CLAY LOAM
 AS FILLER, SUBANGULAR BLOCKY, FRIABLE, MOTTLING @ 42",
 COMMON, MEDIUM, DISTRICT 10YR7/1

SEEPAGE @ 50"

SOIL TESTS CONDUCTED BY ERIC RUPNARAIN, NJPE #44508, GOLDENBAUM BAILL ENGINEERING, INC., 1509 ROUTE 179, LAMBERTVILLE, NJ 08530

Owner / Project

PRELIMINARY AND FINAL
SITE PLAN APPLICATION
587 HAMILTON STREET
BLOCK 204 LOTS 18-22
FRANKLIN TOWNSHIP, NEW JERSEY

RONALD J. SADOWSKI, P.E.

ENGINEERING & CONSTRUCTION MANAGEMENT


10 EDWARD AVENUE


EDISON, NEW JERSEY 08820 (732) 744-6392 ronsadowski@verizon.net


> PROPOSED GRADING, DRAINAGE & UTILITY PLAN

DRAWN RJS CHECKED RJS	SCALE DATE	AS NOTE 01AUG20	D
Rula I. Salowshi		OJECT	No
out of the second	S	20200	
RONALD J. SADOWSKI PROFESSIONAL ENGINEER	DRA	AWING	N
NJPE #38261		5	




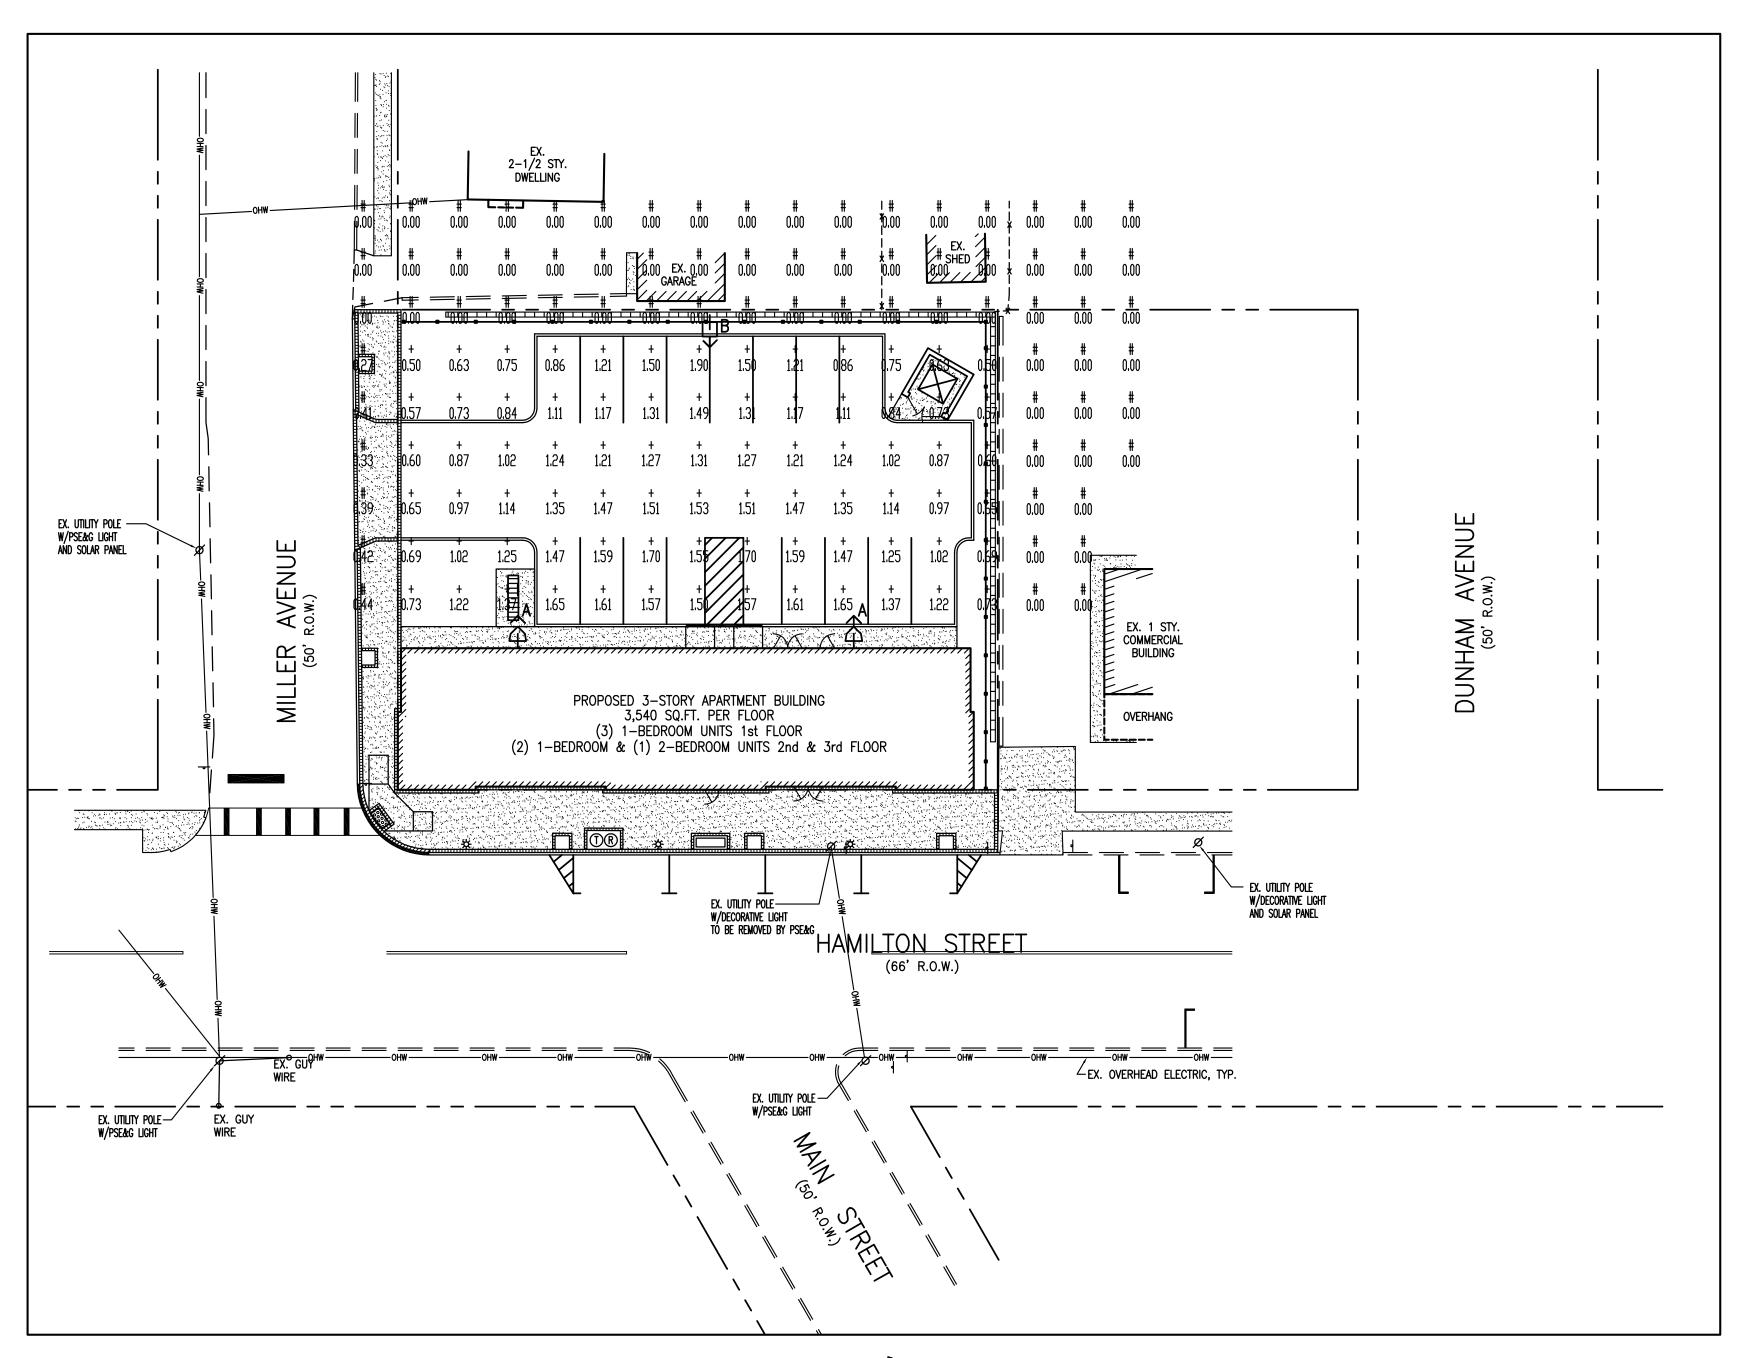

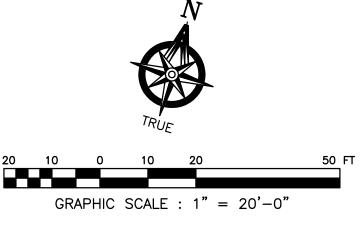

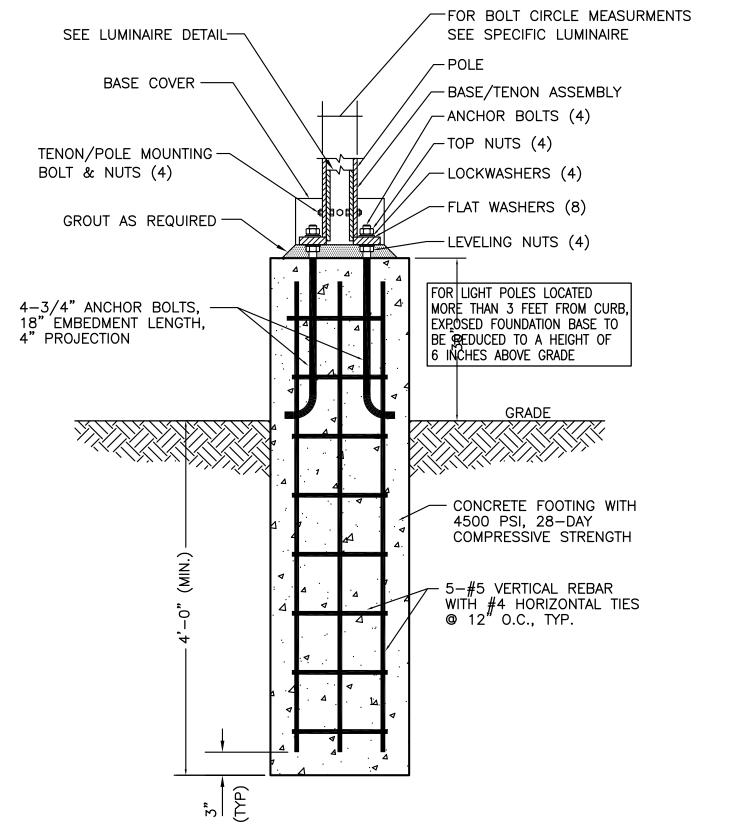

TYPICAL CONCRETE LIGHT POLE FOUNDATION N.T.S.

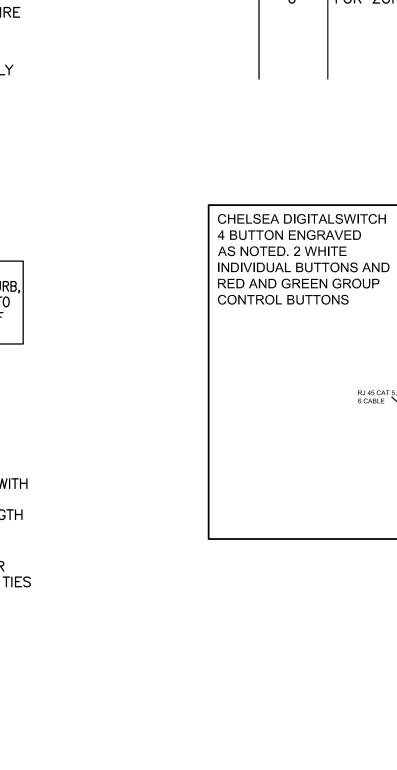

LIGHT POLES ARE 4.5" ROUND, TYP.

POLE-MOUNTED LIGHT DETAIL

REFERENCES

REVISION DESCRIPTION

SELF CONTAINED ASTRONOMICAL TIME CLOCK WITH (2) DUAL

SWITCH

POLE 20 AMP @ RELAYS

AND DIGITAL REMOTE

EXTERIOR

← 120 TO 277 INPUT VOLTAGE —

TO CONTROL CIRCUITS →

MOUNTED

PHOTOCELL

300CT20

0 FOR ZONING BOARD APPROVAL.

BALANCE OF SITE PLAN DRAWINGS.

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IIN AVE/MIN
10.70
12.30
N/A
_

I CAMBUL I CAMBU	(SET (031317) LUMINAIRE SCHEDULE	LIAMD	LLIMENC	DTTAW	I MOLINTING /RALLAST	IIIE	ΙΛΤΥ	MH'
\$	LITHONIA 1W-DSX0 LED-20C-530-40K-TFTM-VOLTS-COLOR-WB-HS-A3	(1)	25266	45	BUILDING SURFACE MOUNTED FIXTURE 16.5' ABOVE GRADE	0.85	2	16.5
â	LITHONIA 1A-DSX0 LED-20C-530-40K-T4M-VOLTS-COLOR-RPA-HS-A3	(1)	24530	4 5	1400-45456S4-1A-COLOR-A3 ON 2.5' CONCRETE PIER FIXTURE 16.5' ABOVE GRADE	0.85	1	16.5
	SYMBOL 3	SYMBOL DESCRIPTION LITHONIA 1W-DSX0 LED-20C-530-40K-TFTM-VOLTS-COLOR-WB-HS-A3 LITHONIA LARGE LED 200 F70 40K T444 VOLTS COLOR DRA HS A7	\$ LITHONIA 1W-DSX0 LED-20C-530-40K-TFTM-VOLTS-COLOR-WB-HS-A3 (1)	SYMBOL DESCRIPTION LAMP LUMENS LITHONIA 1W-DSX0 LED-20C-530-40K-TFTM-VOLTS-COLOR-WB-HS-A3 LITHONIA LAMP LUMENS (1) 25266	SYMBOL DESCRIPTION LAMP LUMENS WATTS LITHONIA 1W-DSX0 LED-20C-530-40K-TFTM-VOLTS-COLOR-WB-HS-A3 LITHONIA LITHONIA LAMP LUMENS WATTS (1) 25266 45	SYMBOL DESCRIPTION LITHONIA \$ 1W-DSX0 LED-20C-530-40K-TFTM-VOLTS-COLOR-WB-HS-A3 LITHONIA LIT	SYMBOL DESCRIPTION LAMP LUMENS WATTS MOUNTING/BALLAST LLF LITHONIA 1W-DSX0 LED-20C-530-40K-TFTM-VOLTS-COLOR-WB-HS-A3 (1) 25266 45 FIXTURE 16.5' ABOVE GRADE 0.85 LITHONIA 1A-DSX0 LED-20C-530-40K-T4M-VOLTS-COLOR-RPA-HS-A3 (1) 24530 45 ON 2.5' CONCRETE PIER 0.85	SYMBOL DESCRIPTION LAMP LUMENS WATTS MOUNTING/BALLAST LLF QTY LITHONIA 1W-DSX0 LED-20C-530-40K-TFTM-VOLTS-COLOR-WB-HS-A3 LITHONIA LITHONIA 1A-DSX0 LED-20C-530-40K-T4M-VOLTS-COLOR-RPA-HS-A3 (1) 24530 45 ON 2.5' CONCRETE PIER 0.85 1

NOTE: HOUSE-SIDE SHIELDS TO BE INSTALLED SHOULD LIGHT LEVELS EXCEED 0.1 FOOT-CANDLES AT PROPERTY LINE.

Owner / Proi

PRELIMINARY AND FINAL
SITE PLAN APPLICATION
587 HAMILTON STREET
BLOCK 204 LOTS 18-22
FRANKLIN TOWNSHIP, NEW JERSEY

RONALD J. SADOWSKI, P.E.


ENGINEERING & CONSTRUCTION MANAGEMENT

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(732) 744-6392
ronsadowski@verizon.net


PROPOSED LIGHTING PLAN

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GRAPHIC SCALE : 1" = 20'-0"

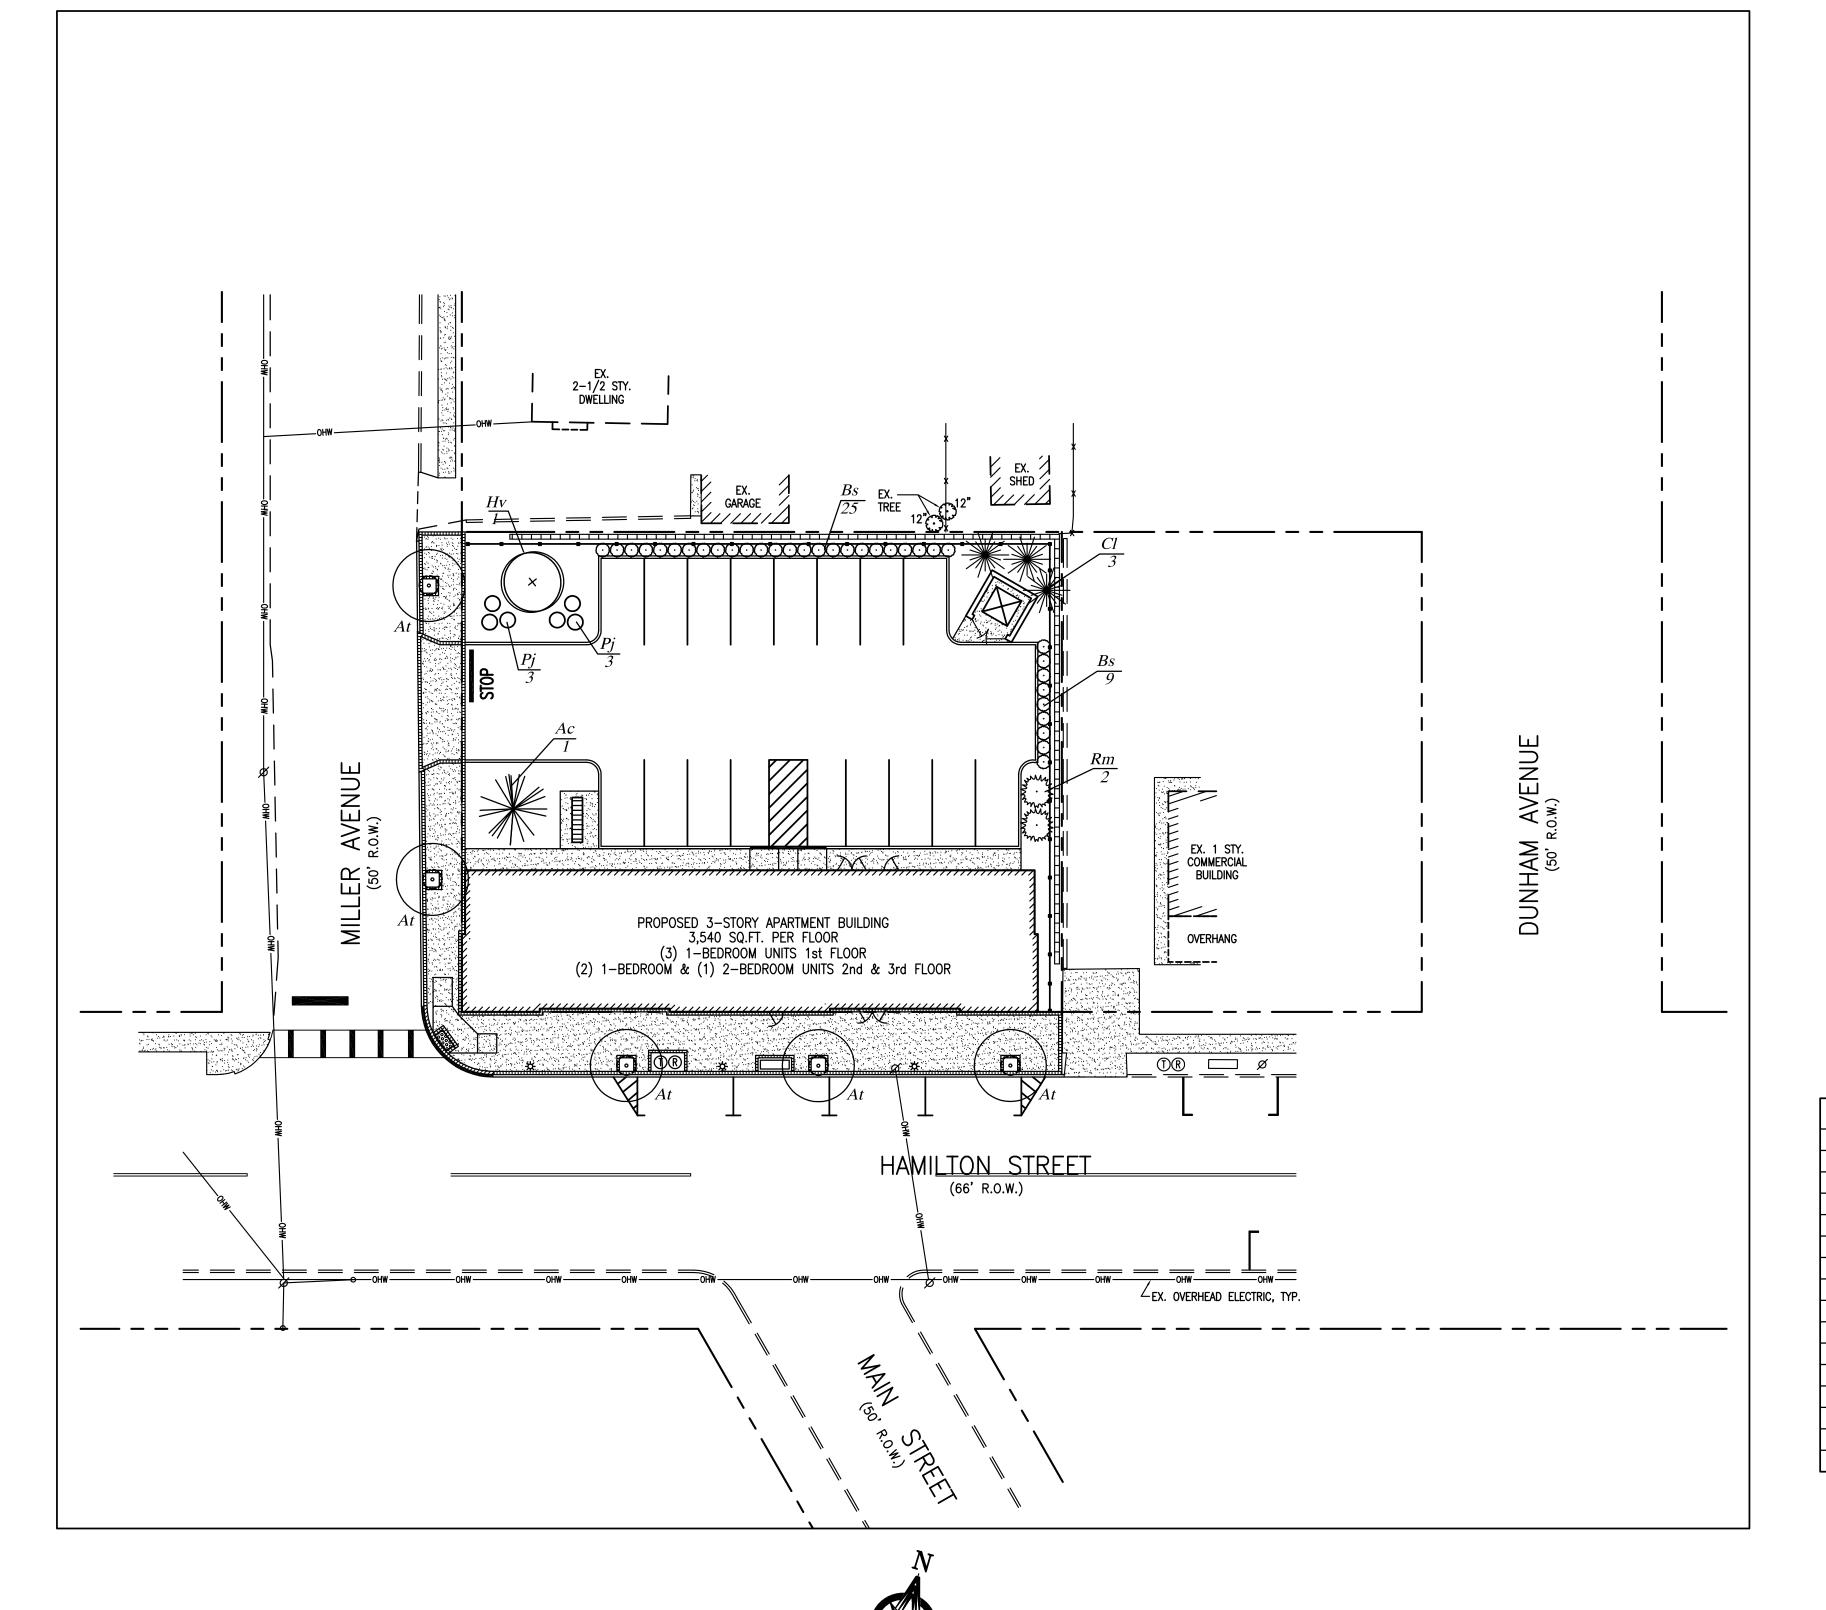

PLANTING NOTES

- ALL PLANT MATERIAL TO BE FIRST QUALITY, NURSERY GROWN STOCK, FREE FROM DISEASE OR OBJECTIONABLE DISFIGUREMENTS. QUALITY AND SIZE OF PLANTS, INCLUDING ROOT SIZE SHALL BE IN ACCORDANCE WITH "AMERICAN STANDARDS FOR NURSERY STOCK" ANSI Z60.1 (MOST RECENT ADDITION) AS PUBLISHED BY THE AMERICAN ASSOCIATION OF NURSERYMEN.
- CONTRACTOR TO VERIFY ALL PLANT DISCREPANCIES INCLUDING PLANT QUANTITIES BETWEEN PLANT LIST AND PLAN. CONTRACTOR SHALL BE RESPONSIBLE FOR INSTALLING QUANTITY WHICH IS GREATER.
- NO SUBSTITUTES SHALL BE PERMITTED WITHOUT WRITTEN APPROVAL OF THE LANDSCAPE ARCHITECT.
- 4. ALL PROPOSED PLANT MATERIAL SHALL BE BALLED AND BURLAPPED UNLESS NOTED OTHERWISE ON PLANTING SCHEDULE.
- ALL INSTALLED PLANT MATERIALS SHALL BEAR THE SAME RELATION TO GRADE WHEN INSTALLED ON SITE AS EXISTED IN NURSERY PRIOR TO DIGGING.
- HOLES FOR PLANT MATERIALS (B&B) SHALL BE DUG A MINIMUM OF TWICE THE BALL DIAMETER. ALL PLANTS SHALL BE LOCATED IN THE CENTER OF THEIR RESPECTIVE PITS.
- B&B PLANTS SHALL BE HANDLED FROM THE BOTTOM OF THE ROOT BALL ONLY. PLANTS WITH BROKEN, SLIT OR DAMAGED ROOT BALLS SHALL BE REJECTED.
- 8. PLANTS SHALL NOT BE BOUND AT ANY TIME WITH WIRE OR ROPE AS TO DAMAGE THE BARK AND BRANCHES.
- PLANT MATERIAL SHALL BE PLANTED ON THE DAY OF DELIVERY. IN THE EVENT THIS IS NOT POSSIBLE THE CONTRACTOR WILL PROTECT THE STOCK THAT IS NOT PLANTED AND KEEP WELL WATERED. PLANTS SHALL NOT REMAIN UNPLANTED FOR MORE THAN A THREE DAY PERIOD AFTER BEING DELIVERED.
- ALL STAKING AND GUYING WIRES SHALL BE FLAGGED WITH A BRIGHT REFLECTIVE MATERIAL TO WARN PEDESTRIANS
- 11. TOPSOIL AND SEED ALL AREAS DISTURBED BY CONSTRUCTION AND ALL LOCATIONS SHOWN AS LAWN AREAS ON PLAN.
- ALL PLANTS SHALL BE PLANTED IN AN APPROVED BACKFILL MIXTURE THAT IS THOROUGHLY WATERED AND TAMPED AS BACKFILLING PROGRESSES. ONLY SUITABLE TOPSOIL, FREE OF DRY SOD, STIFF CLAY, LITTER ETC., SHALL BE USED FOR PLANTING
- 13. ALL SHRUB BEDS AND TREE SAUCERS TO BE MULCHED AS DETAILED.
- 14. THE CONTRACTOR SHALL REPORT ANY SOIL OR DRAINAGE CONDITIONS CONSIDERED DETRIMENTAL TO THE GROWTH OF ANY OF THE PROPOSED PLANTING MATERIAL.
- 15. PROVIDE SNOW/TREE PROTECTION FENCING AS REQUIRED AROUND EXISTING TREES TO BE SAVED.
- 16. CONTRACTOR SHALL GUARANTEE ALL PLANT MATERIAL (NOT INCLUDING LAWNS) FOR A PERIOD OF TWO (2) YEARS FROM DATE OF ACCEPTANCE.
- 17. AFTER THE PLANTING CONTRACTOR HAS COMPLETED THE TERMS OF HIS CONTRACT, THE OWNER SHALL BE RESPONSIBLE FOR THE MAINTENANCE OF ALL PROPOSED PLANTINGS BY PROVIDING THE CORRECT METHODS OF WEEDING, SPRAYING, WATERING, PRUNING AND FERTILIZING ACCORDING TO GOOD HORTICULTURAL PRACTICE.
- 18. ALL TREES TO BE BRANCHED 7' HIGH.

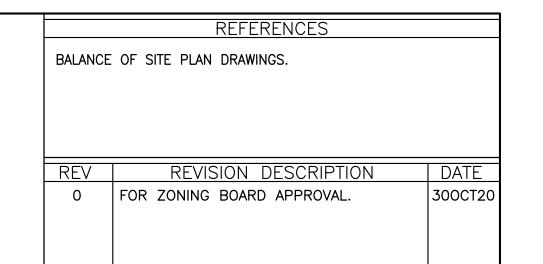			CCHEDITIE			
		PLANTING	<u>SCHEDULE</u>			
KEY	QTY.	BOTANICAL NAME	COMMON NAME	SIZE	ROOT	SPACING
SHADE TREES						
At	5	ACER TATARICUM	TATARIAN MAPLE	2.5-3" CAL.	B&B	AS SHOWN
		ORNAMENTAL TREES				
Hv	1	HAMAMELIS VERNALIS	VERNAL WITCHHAZEL	6-7' HT.	B&B	AS SHOWN
		EVERGREEN TREES		•		
Ac	1	ABIES CONCOLOR	WHITE FIR	7-8' HT.	B&B	AS SHOWN
CI	3	CUPRESSOCYPARIS LEYLANDII	LEYLAND CYPRESS	6-7' HT.	B&B	8' O.C.
		EVERGREEN SHRUBS		•		
Bs	34	BUXUS SEMPERVIRENS	GREEN VELVET BOXWOOD	18-24" HT.	CONT.	3' O.C.
Rm	2	RHODODENDRON MAXIMUM	ROSEBAY RHODODENDRON	3-4' HT.	B&B	6' O.C.
Pj	6	PIERIS JAPONICA	MOUNTAIN FIRE ANDROMEDA	18-24"	CONT.	3' O.C.
-						

ALL PLANT RELOCATIONS/SUBSTITUTIONS SHALL BE SUBMITTED TO THE TOWNSHIP FOR REVIEW AND APPROVAL PRIOR TO INSTALLATION.

NO TREES SHALL BE WITHIN 10 FEET OF ANY SANITARY LATERAL OR MAIN.

PRELIMINARY AND FINAL SITE PLAN APPLICATION 587 HAMILTON STREET BLOCK 204 LOTS 18-22 FRANKLIN TOWNSHIP, NEW JERSEY

RONALD J. SADOWSKI, P.E.

ENGINEERING & CONSTRUCTION MANAGEMENT 10 EDWARD AVENUE EDISON, NEW JERSEY 08820 (732) 744-6392ronsadowski@verizon.net

> PROPOSED LANDSCAPING PLAN

> > SCALE AS NOTED DATE 16AUG20


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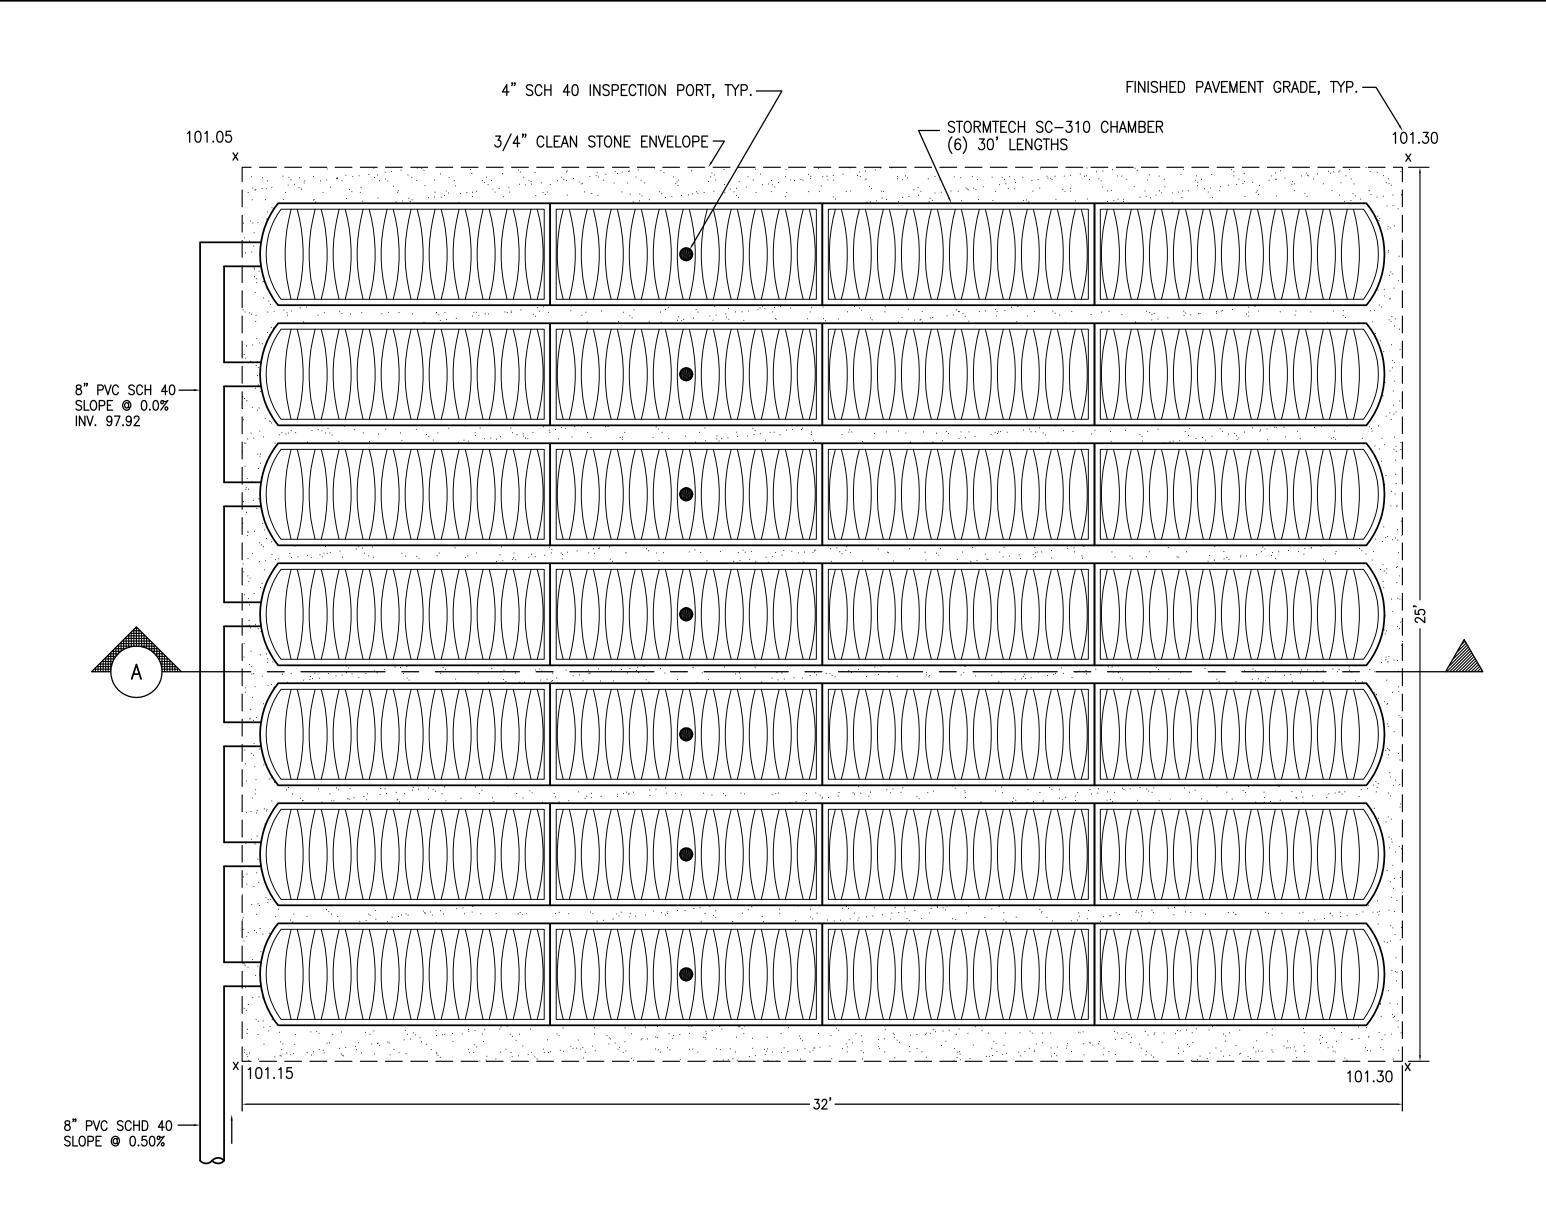
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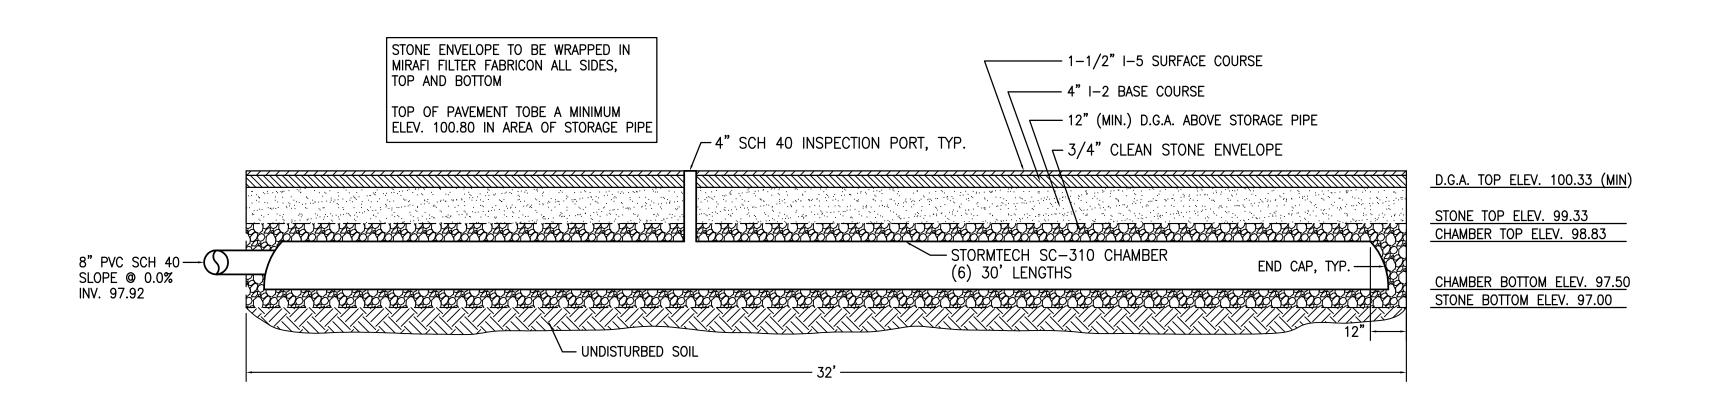
RONALD J. SADOWSKI PROFESSIONAL ENGINEER NJPE #38261 DRAWING NO.





UNDERGROUND STORAGE PLAN VIEW



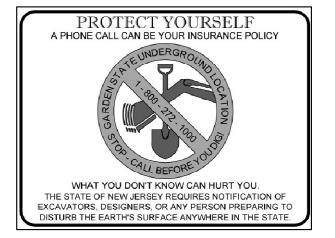

UNDERGROUND STORAGE SECTION A



	REFERENCES	
REV	REVISION DESCRIPTION	DATE
0	FOR PLANNING BOARD APPROVAL.	300CT20
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PRELIMINARY AND FINAL
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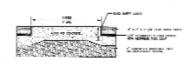
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DRAINAGE SYSTEM PLAN AND SECTION


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RONALD J. SADOWSKI PROFESSIONAL ENGINEER NJPE #38261	DRAWING NO.






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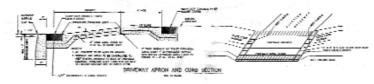



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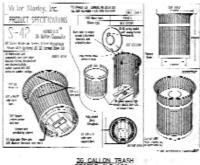

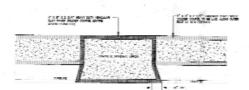
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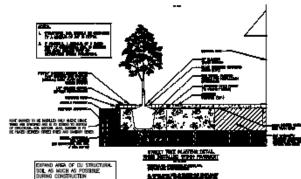





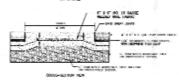

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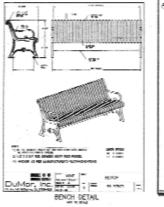
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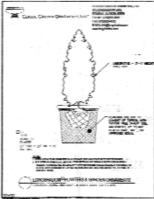
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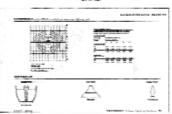


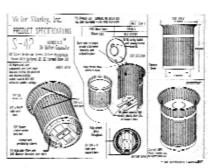


PLANTER DETAILS

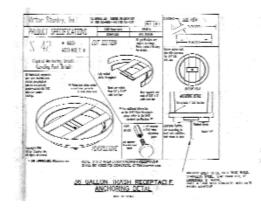

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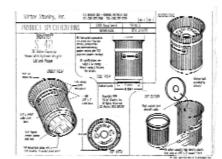
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STREETSCAPE CONSTRUCTION DETAILS

DBAWN R78 CHRCKED R78	SCALE AS NOTED DATE GLAUGES
Rolling	PROJECT NO.
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RONALD J. SADOWSKI PROFESSIONAL ENGINEER N. IPP. 438281	DRAWING NO.

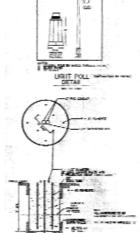

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