

- 1. As-Built plan to be based upon approved plot plan. Two original signed and sealed paper copies shall be submitted.
- 2. Show proposed elevations (cross out) and actual elevations.
- 3. Storm sewer grate, rim and invert elevations. Show as-built pipe size, material, length and slope in plan view.
- 4. Show as-built contour elevations to demonstrate surface drainage.
- 5. Show spot elevations to delineate swales.
- 6. Show sanitary sewer clean-outs in plan view. 7. Building footprint location with offsets to nearest property lines. As-built elevations at building corners and 10' away from corners.
- 8. First floor, garage floor and basement floor elevations.
- 9. Show a cross section of the roadway where the driveway intersects the edge of pavement showing any gutters or cross pipes constructed to maintain the preexisting drainage flow.
- 10. Location and dimensions of all improvements proposed on plot plan (building additions, pools, sheds, drives, walks, curb, trees, etc).
- 11. CAD-generated data files, prepared by a New Jersey licensed land surveyor, directly translatable into an identical image of the as-built plan (Requirements per Section 112-329). Electronic files (dwg or dxf) may be sent to the following e-mail address: engineering.requests@twp.franklin.nj.us

ZONING BOARD APPROVAL: NOTE: As-built information necessary only in areas disturbed by construction and only on newly constructed improvements. As-built plan to be submitted prior to CHAIRPERSON — ZONING BOARD DATE Certificate of Occupancy inspection. DATE SECRETARY - ZONING BOARD Rev 3/26/14 (FRANKLIN TOWNSHIP, SOMERSET COUNTY STANDARD DETAILS) TOWNSHIP ENGINEER DATE

TFSTING,

APPLICATION No.

THE TOWNSHIP PRIOR TO A CERTIFICATE OF OCCUPANCY INSPECTION OR RELEASE

SITE UNTIL A SOIL IMPORTATION OR EXPORTATION PERMIT IS OBTAINED FROM THE

THE SUBGRADE OF ALL STREETS AND PARKING AREAS MUST BE PROOF-ROLLED USING

A TRI-AXLE TANDEM DUMP TRUCK WITH A MINIMUM CERTIFIED WEIGHT OF 70,000

LBS FULLY LOADED. THE PROOF-ROLL IS TO BE CONDUCTED UNDER THE DIRECT

NOTE THAT ALL CASTINGS SHALL BE OF UNITED STATES MANUFACTURE AND NJDOT

APPROVED. IF OTHER THAN CAMPBELL, NEENAH, BRIDGESTATE, EMPORIA, QUIRIN

OR EAST JORDAN IRONWORKS CASTINGS ARE PLANNED TO BE USED, COMPLETE DATA

MUST BE SUBMITTED INCLUDING, BUT NOT NECESSARILY LIMITED TO, AN AFFIDAVIT

CERTIFYING THAT THE CASTINGS WERE MADE IN THE U.S.: LOAD CAPACITY BASED

ON THE STANDARD HIGHWAY LOADING; WEIGHTS AND CONFIGURATIONS OF THE

CASTINGS AND METALLURGICAL ANALYSIS. ALL GRATES ARE TO BE "BICYCLE

NOTE: THE PROPOSED GRADE AWAY FROM THE FOUNDATION WALL SHALL FALL A

MINIMUM OF 6 INCHES WITHIN THE FIRST 10 FEET PER NEW JERSEY BUILDING

DATE

OF THE PERFORMANCE BOND. NO SOIL CAN BE IMPORTED TO OR REMOVED FROM THE

ENGINEERING DEPARTMENT, IN ACCORDANCE WIT SECTION 112-8N OF THE

SUPERVISION OF THE TOWNSHIP ENGINEER OR HIS REPRESENTATIVE.

——W——WATER SERVICE ——G——G—— GAS SERVICE -----SAN------ EXISTING SANITARY SEWER EXISTING WATER VALVE **⊿** € 2 SOIL LOG FFF FIRST FLOOR FINISHED FLOOR ELEVATION FGF FINISHED GARAGE FLOOR ELEVATION

PROPOSED BUILDING RENOVATION,

E:\.IOBEILE\2008ES\ENG\DWG\2008ES-L38-44 PLOT (12-15-22) DWG

ADDITION & IMPROVEMENTS

- 4. THERE ARE NO OBSERVED OR IDENTIFIED WETLANDS ON THE PROPERTY. THERE ARE NO DELINEATED FLOOD PLAINS ON THE PROPERTY.
- 5. NO SOIL CAN BE IMPORTED TO OR REMOVED FROM THE SITE UNTIL A SOIL IMPORTATION OR EXPORTATION PERMIT, AS REQUIRED BY ORDINANCE, HAS BEEN OBTAINED FROM THE TOWNSHIP. SOIL REMOVAL SHALL BE IN ACCORDANCE WITH SECTION 112-8N OF THE ORDINANCE.
- 6. ANTICIPATED SEWERAGE USE ESTIMATED AT 300 GPD PER UNIT X 2 = 600 GPD.
- 7. AN AS-BUILT PLAN PREPARED BY A LICENSED NEW JERSEY LAND SURVEYOR IS TO BE SUBMITTED TO THE TOWNSHIP PRIOR TO A CERTIFICATE OF OCCUPANCY INSPECTION. THE APPLICANT SHALL ALSO SUBMIT CAD-GENERATED DATA FILES, PREPARED BY A NEW JERSEY LICENSED LAND SURVEYOR, DIRECTLY TRANSLATABLE INTO AN IDENTICAL IMAGE OF THE AS-BUILT PLAN PER THE REQUIREMENTS OF SECTION 112-239.
- 8. NO EXISTING TREES ARE TO BE REMOVED. STREET TREES ARE PROPOSED AS SHOWN
- 9. ONLY COMPLETE SECTION OF EXISTING CURB MAY BE REMOVED AND REPLACED, NO SAW CUTTING OF EXISTING CURB IS ALLOWED PER TOWNSHIP ENGINEERING DEPARTMENT.
- 10. AT TIME OF CONSTRUCTION, A ROAD OPENING PERMIT SHALL BE OBTAINED FROM THE DEPARTMENT OF PUBLIC WORKS.

1. "BOUNDARY & TOPOGRAPHIC SURVEY OF BLOCK 174, LOTS 30-44, FRANKLIN TOWNSHIP SOMERSET COUNTY, NEW JERSEY" BY VAN CLEEF ENGINEERING ASSOCIATES, LLC, PAMELA MATHEWS, N.J.P.E. & L.S. LIC. No. 41181, LAST REVISED FEB. 24, 2021.

FRANKLIN TOWNSHIP TAX MAP SHEET No. 80.02

GABRIEL MERCADO AND LUZILDA MERCADO-ESPARRA

"C", 4 SPACES PROPOSED

STANDARD

REQUIREMENTS

15,000 S.F.

150 FT.

25 FT.

8 FT.

20 FT.

20 FT.

20 %

8 FT.

10 FT.

3 FT.

5 FT.

35 FT./2 1/2 STY

OWNER/ APPLICANT

PARKING REQUIREMENTS

NJAC 5.21-4.14(d)3.

109 CLYDE ROAD

SOMERSET, NJ 08873

2 - 4 BEDROOM UNITS

2.5 P.S./UNIT

R-7 2F ZONE SCHEDULE (RESIDENTIAL)

PRINCIPAL BUILDING

MINIMUM LOT AREA (CORNER LOT)

MINIMUM FRONT YARD SETBACK

MINIMUM SIDE YARD SETBACK

MINIMUM REAR YARD SETBACK

MINIMUM SIDE YARD SETBACK

MINIMUM REAR YARD SETBACK

MINIMUM SIDE YARD SETBACK

MINIMUM REAR YARD SETBACK

(1) BULK VARIANCE REQUIRED

(2) EXISTING NON-CONFORMITY

PLAN REFERENCES:

GARDEN SHED (100 S.F. OR LESS)

MAXIMUM BUILDING HEIGHT

ACCESSORY BUILDING

MINIMUM LOT FRONTAGE (CORNER LOT)

MAXIMUM LOT COVERAGE BY BUILDINGS

MAXIMUM IMPERVIOUS COVERAGE (LOT)

MINIMUM TOTAL OF TWO SIDE YARD SETBACKS

KEY MAP

PROPOSED DRIVEWAY 20'X 36' DRIVEWAY (3-4 SPACES*) PLUS

PARKING (3 SPACES) ON LILLIAN ST. PER R.S.I.S. NJAC

5.21-4.16 TABLE 4.4 INCLUDING FOOTNOTE "C", 3 SPACES

EXISTING

17,626 S.F.

8.3 FT.

0 FT.

58.7 FT.

NA

25.0%

< 35 FT./2 1/2 STY

LOT 38.01

164.61 FT. (HENRY ST.)

ON STREET PARKING (3 SPACES) ON LILLIAN ST. PER R.S.I.S. NJAC 5.21-4.16 TABLE 4.4 INCLUDING FOOTNOTE

EAST UNIT: PROPOSED 18'X 18' DRIVEWAY (2 SPACES) PLUS ON STREET

(*) SIMILAR TO 2 CAR GARAGE AND DRIVEWAY COMBINATION PER RSIS

- 2. ARCHITECTURAL PLANS ENTITLED "ADDITION & ALTERATIONS: TO A SINGLE DWELLING. CONVERTING ONE DWELLING TO A DUPLEX 85 HENRY STREET SOMERSET, NJ OWNER: GILBERT MERCADO" BY LARRY C. JOHNSON ARCHITECTURE PLANNING INTERIORS AL 08215, 40A CAMNER AVENUE SOMERSET, NJ 08873, DATED 11/18/2021, SHEETS A1 - A7.
- 3. DEED BOOK 743, PAGES 3429-3436.

				DATE: JULY	22, 2022	
				SCALE:	1" = 20'	
				DESIGNED BY:	M.K.F.	
PE	R TWP.	M.K.F.	12/15/22	DRAWN BY:	A.B.	
PE	R CLIENT	M.K.F.	10/10/22	CHECKED BY:	M.K.F.	
	REVISIONS	AUTH.	DATE	JOB No.	2008FS	With Offices In New Jersey, Pennsy

Michael K. Ford

Michael K. Ford, P.E.

32 BROWER LANE, PO BOX 5877, HILLSBOROUGH, NJ 08844

Water / Wastewater Municipal Engineering Land Surveying Professional Planning Landscape Architecture NJ LLC CERT. No. 24GA28132300

Construction Inspection Geotechnical Engineering

SCALE: 1"=20

PROPOSED

LOT 38.01

17,626 S.F.

164.61 FT. (HENRY ST.)

25.1 FT.

32.0 FT.

90.7 FT.

13.4%

21.2%

< 35 FT./2 1/2 STY


100.00 FT. (LILLIAN ST.) (2) 100.00 FT. (LILLIAN ST.) (1

WEB: WWW.VANCLEEFENGINEERING.COM PHONE (908) 359-8291 FAX (908) 359-1580 PLOT & GRADING PLAN

BLOCK 174 LOT 38.01 (INCLUDING FRM LOTS 38 - 44)

SITUATED IN FRANKLIN TOWNSHIP, SOMERSET COUNTY, NEW JERSEY

Professional Engineer, New Jersey Lic. No. 34722

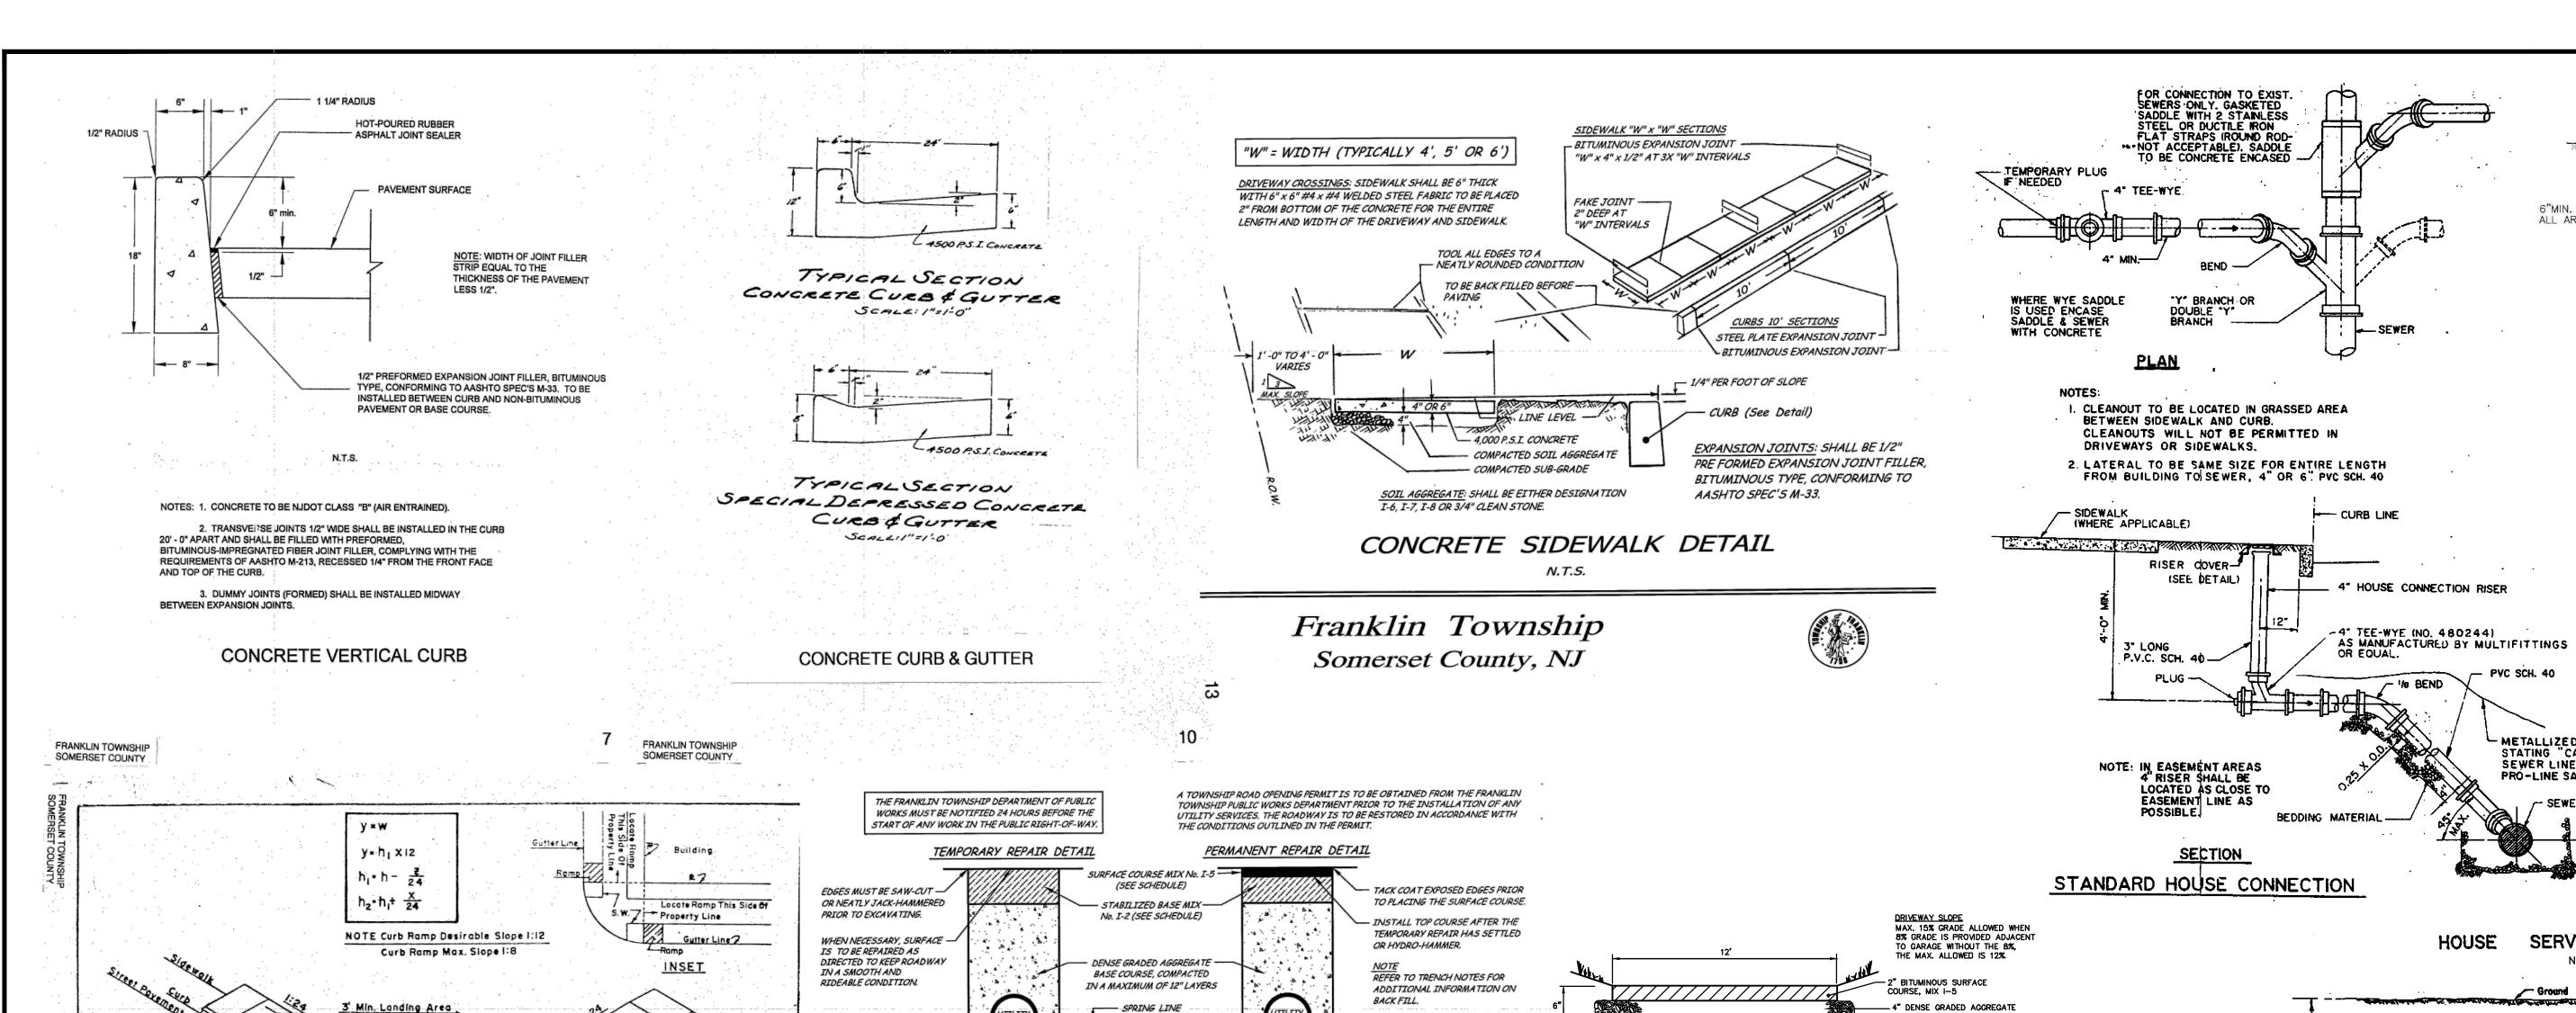

RESTORATION OF STREET OPENINGS

N.T.S.

- 3/4 CLEAN CRUSHED STONE TO-THE SPRING LINE OF THE PIPE FOR DUCTILE IRON WATER PIPES

AND STORM SEWERS.

Franklin Township Somerset County, NJ

CURB RAMPS FOR THE PHYSICALLY HANDICAPPED

SCHEDULE :

SCHEDULE:

NEW JERSEY DEPARTMENT OF TRANSPORTATION

DESIGN STANDARDS

7/19/76

ROAD CLASS	USUAL PAVEMENT WIDTH	USUAL R.O.W. WIDTH	STABILIZED BASE	F.A.B.C. TOP TOP	USE
LOCAL RESIDENTIAL	30 FEET	50 FEET	4 INCHES	1 1/2 INCHES	Х
LOCAL NON-RESIDENTIAL	40 FEET	60 FEET	6 INCHES	1 1/2 INCHES	
COLLECTOR-RESIDENTIAL	36 FEET	60 FEET	6 INCHES	2 INCHES	
COLLECTOR NON-RESIDENTIAL	42 FEET	66 FEET	7 INCHES	2 INCHES	
MAJOR COLLECTOR	48 FEET	72 FEET	7 INCHES	2 INCHES	
ARTERIAL	50 FEET	80-100 FEET	7 INCHES	2 INCHES	

THE FRANKLIN TOWNSHIP DEPARTMENT OF PUBLIC

BEEN CONSTRUCTED SHALL BE BACKFILLED AS INDICATED ABOVE OR MAYBE BACKFILLED WITH SUITABLE ON-SITE EXCAVATED MATERIALS OR IMPORTED FILL PRIOR TO USING ANY ON-SITE AND/OR IMPORTED SOIL MATERIALS THE CONTRACTOR OR ANY INDIVIDUAL OR FIRM SHALL EMPLOY A RECOGNIZED SOILS LABORATORY TO SECURE SOIL SAMPLES; PERFORM THE NECESSARY LABORATORY ANALYSIS AND ESTABLISH THE COMPACTION AND OTHER CRITERIA NECESSARY FOR THE PROPER PLACEMENT OF THE BACKFILL. REPORT OF THE LABORATORY FINDINGS, INCLUDING THE COMPACTION SPECIFICATIONS, SHALL BE SUBMITTED TO THE TOWNSHIP ENGINEER FOR REVIEW AND APPROVAL PRIOR TO COMMENCING ANY BACKFILL OPERATIONS USING ON-SITE SOIL AND/OR IMPORTED SOIL MATERIALS.

ALL TRENCHES OR DITCHES WHICH CROSS AN EXISTING STREET OR WHICH ARE DUG FOR SEWERS, WATER MAINS, GAS MAINS OR OTHER UTILITIES, INCLUDING THE HOUSE CONNECTIONS FOR THESE UTILITIES, SHALL BE FILLED WITH QUARRY PROCESS STONE. THE STONE SHALL BE PLACES IN LAYERS NOT EXCEEDING TWELVE (12) INCHES IN DEPTH AND SHALL BE SPRINKLED WITH WATER AND

MECHANICALLY COMPACTED. ALL SOFT SPOTS AND DEPRESSIONS IN A SURFACE WHICH AS BEEN GRADED WILL BE REMOVED AND FILLED WITH STONE OF A SIZE TO

BE DETERMINED BY THE TOWNSHIP ENGINEER. ALL TRENCHES WHICH ARE DUG IN A

FUTURE STREET OR EXISTING R.O.W., ON WHICH NO SUBBASE OR PAYEMENT HAS

NOTE Ramps & Side Ramp

Hand Broom Finished

Ramp Elv. At Gutter Line

TRENCHES.

Flush With Street Pavement


Section Through Romp

---3' Min. Sidewalk

Londing Area


DURING THE BACKFILLING OPERATIONS, THE CONTRACTOR OR ANY INDIVIDUAL OR FIRM ENGAGED IN A BACKFILLING OPERATION SHALL EMPLOY A PROFESSIONAL ENGINEER, LICENSED IN THE STATE OF NEW JERSEY, OR HIS REPRESENTATIVE, who is regularly engaged in the practice of Geotechnical engineering AND WHO IS TRAINED IN SOIL MECHANICS, TO OBSERVE THE PLACEMENT OF THI BACKFILL. THE SOILS ENGINEER SHALL FILE DAILY REPORTS, WITH THE TOWNSHIP ENGINEER INDICATING THE RESULTS OF THE COMPACTION AND UPON THE CONCLUSION OF THE PROJECT FILE A FINAL CERTIFICATION INDICATING THAT THE BACKFILL MATERIAL HAS BEEN PLACED AND COMPACTED IN ACCORDANCE WITH THE RECOMMENDATIONS CONTAINED IN THE APPROVED LABORATORY REPORT

NOTE: A STREET OPENING PERMIT IS REQUIRED FOR THE PROPOSED WATER AND

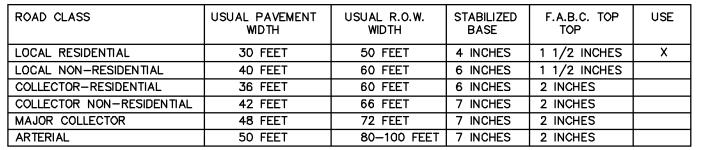

PERMANENT TEMPORARY WORKS MUST BE NOTIFIED 24 HOURS BEFORE THE START OF ANY WORK IN THE PUBLIC RIGHT-OF-WAY REPAIR DETAIL REPAIR DETAIL - TACK COAT EXPOSED STABILIZED BASE MIX No. I-2-EDGES MUST BE-EDGES PRIOR TO PLACING (SEE SCHEDULE) SAWCUT OR THE F.A.B.C. TOP. JACK HAMMERED PRIOR - SUB-BASE QUARRY STONE - INSTALL F.A.B.C. TOP TO EXCAVATION AFTER THE TEMPORARY REPAIR HAS SETTLED QUARRY STONE, TYPE I-5, -OR HYDRO-HAMMER. COMPACTED IN A MAXIMUM OF 12" LAYERS (TYPICAL). REFER TO SECTION 210.45 "TRENCHES" FOR ADDITONAL INFORMATION ON BACK-FILL. 3/4" CLEAN CRUSHED STONE TO THE SPRING LINE OF THE PIPE FOR DUCTILE IRON WATER MAINS AND STORM SEWERS.

RESTORATION OF STREET OPENINGS

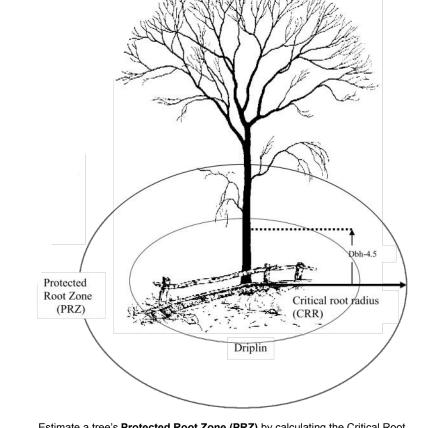

Estimate a tree's **Protected Root Zone (PRZ)** by calculating the Critical Root Radius (crr).

1. Measure the dbh (diameter of tree at breast height, 4.5 feet above ground on the uphill side of tree) in inches. 2. Multiply measured dbh by 1.5 or 1.0. Express the result in feet.


Dbh x 1.5: **Critical root radius** for older, unhealthy, or sensitive species. Dbh x 1.0: **Critical root radius** for younger, healthy or tolerant species.

ALL EXISTING TREES HAVING A CALIPER OF SIX INCHES OR MORE MEASURED 4.5 FEET OFF THE GROUND THAT ARE NOT REQUIRED TO BE REMOVED BY THE PROPOSED CONSTRUCTION SHALL BE PROTECTED BY THE INSTALLATION OF A SNOW FENCE OR SIMILAR BARRIER FOUR FEET BEYOND THE DRIP LINE OF THE TREE(S) PRIOR TO COMMENCEMENT OF

EXISTING TREE PROTECTION DETAIL

F:\JOBFILE\2008FS\ENG\DWG\2008FS-L38-44 PLOT (12-15-22).DW0

NOT TO SCALE

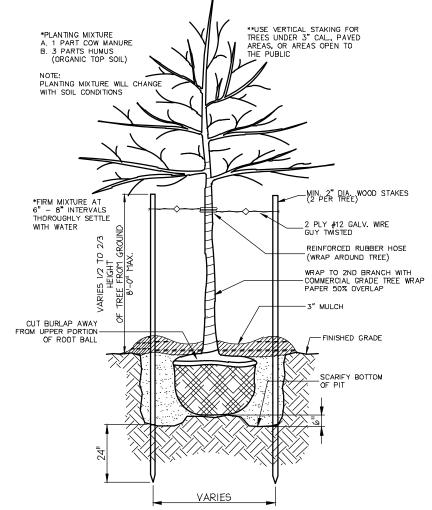

THICKNESS REQUIREMENT MAY BE

REVISED AS DIRECTED BY TOWNSHIP

BITUMINOUS DRIVEWAY TYPICAL SECTION

(FIRST 20 FT. MIN. @ ALL DRIVEWAYS)

DRIVEWAY DETAILS @ TOWNSHIP ROAD

TREE PLANTING AND GUYING DETAIL THE LANDSCAPE CONTRACTOR IS TO REMOVE ALL STAKES

AND WIRES FROM TREES AFTER THE FIRST GROWING SEASON.

Carron of the State of Type	Extension Type Curb Box	
Typ	Less Than I" Connecting Pipe	
Distribution Main	Oriseal Curb Valve APPROVED EQUA	L
WET TAP EXISTIN WATER DEPARTM	IG MAIN PER TOWNSHIP ENT STANDARDS	
	TOP VIEW	
	Mueller Compression Type Corporation Stop Distribution Main	
UTILITY PIPE	Refer to Trench Backfill Notes for Backfill Above Spring Line Spring Line 3/4" Clean Crushed Stone to the Spring Line of the Pipe for Ductile Iron Water Mains	

METALLIZED WARNING TAPE

STATING "CAUTION - BURIED SEWER LINE BELOW " BY

Ground Grode

PRO-LINE SAFETY PRODUCTS CO.

CONNECTION

PVC CAP-

RISER COVER DETAIL

6"MIN. BEDDING MATERIAL

FINISHED GRADE

1000 WITHOUT

UTILITY PIPE BEDDING DETAIL (FRANKLIN TOWNSHIP, SOMERSET COUNTY STANDARD DETAILS)

			DATE: JUL	Y 22, 2022	
			SCALE:	AS SHOWN	
			DESIGNED BY:	M.K.F.	
			DRAWN BY:	A.B.	
LOT NUMBER	M.K.F.	12/15/22	CHECKED BY:	M.K.F.	
REVISIONS	AUTH.	DATE	JOB No.	2008F9	W Ne

With Offices In New Jersey, Pennsylvania & Delaware

Michael K. Ford Michael K. Ford, P.E.

Professional Engineer, New Jersey Lic. No. 34722



CONSTRUCTION DETAILS

and Storm Sewers

BLOCK 174 LOT 38.01 (INCLUDING FRM LOTS 38 - 44)

FRANKLIN TOWNSHIP, SOMERSET COUNTY, NEW JERSEY