#### REFERENCE CODES (ONE & TWO FAMILY DWELLING): \* INTERNATIONAL RESIDENTIAL CODE 2021 NJ EDITION (NJAC 5:23-3:21)

with NJ & ICC errata & ISPSC/2021)

- \* NATIONAL ELECTRICAL CODE (NJAC 5:23-3:16) (NFPA 70) 2020 with (TIA 1-9) \* NATIONAL STANDARD PLUMBING CODE 2021 NJ EDITION with NJ & NSPC errata \* INTERNATIONAL ENERGY CONSERVATION CODE/2021 (Low-Rise Residential) with ASHRAE 90.1-2019(RESIDENTIAL)
- \* INTERNATIONAL MECHANICAL CODE 2021 (NJAC 5:23-3:20)
- \* INTERNATIONAL FUEL GAS CODE 2021
- \* THE REHABILITATION SUBCODE (NJAC 5:23-6)

#### \* BARRIER FREE SUBCODE - NJAC 5:23 - 7 & ICC A117.1 - 2021

- ALL WORK TO BE DONE IN ACCORDANCE WITH THE REFERENCED CODES LISTED ABOVE.
- ALL FOOTINGS TO BEAR ON VIRGIN SOIL ONLY.
- SOIL BEARING CAPACITY ASSUMED TO BE 3000 PSF. IF ACTUAL SOIL BEARING IS DIFFERENT THAN ASSUMED. NOTIFY ARCHITECT BEFORE PROCEEDING. ARCHITECT NOT RESPONSIBLE FOR VERIFICATION OF SUBSURFACE CONDITIONS OR BEARING CAPACITIES.
- STEPPED FOOTINGS (WHERE REQ'D.) TO BE AT A RATIO OF ONE FOOT VERTICAL TO TWO FOOT
- ALL BELOW GRADE BLOCK TO BE HOLLOW LOAD BEARING TYPE.
- ALL CONCRETE TO BE MIN. 3,000 PSI @ 28 DAY STRENGTH. (GARAGE & DRIVEWAY SLAB REQUIRED TO BE 3,500 PSI AIR ENTRAINED CONCRETE).
- ALL MORTAR & GROUT TO BE TYPE "M".
- CONCRETE PROTECTION FOR REINFORCING STEEL SHALL BE 3".
- ALL REINFORCED BARS SHALL BE NEW BILLET STEEL, DEFORMED TYPE, ASTM A615, GRADE 60 & SHALL COMPLY WITH ALL CODE REQUIREMENTS. REBAR TO BE LAPPED (MINIMUM: 20 TIMES THE BAR DIAMETER). ALL FOOTINGS W/ #4 REBAR OR LARGER SHALL PROVIDE GROUNDING WIRE OR REBAR STUB INSTALLED AS PER LOCAL INSPECTORS REQUIREMENTS

DISCREPANCIES AND SOLUTIONS SHALL BE REVIEWED AND APPROVED BY ARCHITECT PRIOR TO FRAMING.

- ALL FRAMING LUMBER TO BE DOUGLAS FIR OR SOUTHERN YELLOW PINE NO. 2. MIN.fs=1,300 PSI. ALL LUMBER IN CONTACT WITH MASONRY TO BE TREATED LUMBER (NOTE: INCLUDE GALVANIZED OR STAINLESS STEEL ANCHOR BOLTS, OR USE LSL STRAND GUARD - TREATED SILL.) (NOTE: ALL PILE CONNECTIONS TO BE STAINLESS STEEL.)
- ALL DIMENSIONS ON PLAN ARE FINISHED DIMENSIONS. CONSULT ARCHITECT FOR FRAMING QUESTIONS OR DESCRIPTIONS PRIOR TO FRAMING. DO NOT NOTCH OR CUT LUMBER IN ANY NON TYPICAL MANNER.
- TREATED LUMBER TO BE ACQ WITH REQUIRED FASTENERS, NAILS, ETC.
- DOUBLE ALL JOISTS UNDER PARALLEL PARTITIONS.
- MICROLLAM OR PARALLAM LUMBER TO BE EQUAL TO TRUS-JOIST CORP. MICROLLAM OR PARALLAM LUMBER WITH MIN. (fb=2,900 PSI) (NOTE: MICROLLAMS INDICATED ON PLANS CAN BE SUBSTITUTED WITH PARALLAMS. COMBINATION OF MICROLLAMS CAN BE SUBSTITUTED WITH (1) SOLID MICROLLAM OR PARALLAM WITH EQUAL TOTAL WIDTH AND HEIGHT AS SPECIFIED).
- CONTRACTOR / OWNER SHALL PROVIDE ARCHITECT WITH MANUFACTURERS SHOP DRAWINGS OF PRE-ENGINEERED JOIST SYSTEM (TJI, BLUELINK, ETC) FOR REVIEW AND APPROVAL. PLANS SHALL NOT BECOME FINAL UNTIL ARCHITECT APPROVAL OF SHOP DRAWINGS.
- ALL NAILING TO BE DONE IN ACCORDANCE WITH REFERENCE INTERNATIONAL RESIDENTIAL CODE.
- ROOM SIZES INDICATED ON PLAN MAY VARY DEPENDING ON EXISTING FIELD CONDITIONS, ETC.
- EXTERIOR TO BE VINYL SIDING TO BE SELECTED BY HOMEOWNER.
- INTERIOR WOOD TRIM TO BE READY TO RECEIVE PAINT.
- INCLUDE CEMENT BACKER BOARD ON SURFACES RECEIVING TILE.
- WINDOWS TO BE ANDERSEN 400 SERIES WITH SCREENS. ALL WINDOW AND DOOR MODEL NUMBERS SHALL BE CONFIRMED BY THE CONTRACTOR.
- ROOF & WALL SHEATHING TO BE 1/2" CDX 32/16 EXTERIOR PLYWOOD.
- ROOFING TO BE FIBERGLASS ROOF SHINGLES TO BE SELECTED BY HOMEOWNER.
- INCLUDE ALL NECESSARY STEP FLASHING, VENT STACK FLASHING, ETC. FOR A COMPLETE INSTALLATION. INCLUDE WEATHERWATCH (OR EQUAL) ICE AND WATER SHIELD AT ALL EAVES, VALLEYS, ETC. INCLUDE ALUMINUM FLASHING AT ALL DECK, PORCH, ETC. CONNECTIONS. INSTALL ALL WINDOWS AND DOORS WITH REQUIRED WEATHER SEALS AS SPECIFIED BY MANUFACTURER.
- ELECTRIC LAYOUT IS SCHEMATIC, ALL ELECTRIC WORK TO COMPLY WITH REFERENCED NATIONAL ELECTRIC CODE. CONFIRM ALL ELECTRIC / LIGHTING WITH HOMEOWNER.
- ALL PLUMBING TO COMPLY WITH REFERENCED NATIONAL STANDARD PLUMBING CODE.
- PROVIDE SHUT-OFF VALVES AT ALL FIXTURES.
- CONTRACTOR RESPONSIBLE FOR OBTAINING ALL NECESSARY PERMITS. OWNER RESPONSIBLE FOR COST AND PAYMENT OF PERMITS.
- CONTRACTOR TO VERIFY ALL CONDITIONS AND DIMENSIONS IN FIELD AND BE RESPONSIBLE FOR SAME. CONTRACTOR SHALL INSPECT EXISTING CONDITIONS AND PLAN / COORDINATE ANY REQUIRED CHANGES DUE TO THE PROPOSED CONSTRUCTION AS NECESSARY. CONTRACTOR IS RESPONSIBLE FOR CONTACTING ARCHITECT WITH ANY QUESTIONS, CLARIFICATION, FIELD DISCREPANCIES, CHANGES, ETC.
- ARCHITECT NOT RESPONSIBLE FOR MEANS AND METHODS OF CONSTRUCTION, COORDINATION, AND SCHEDULING OF GENERAL CONTRACTORS AND SUBCONTRACTORS OR ANYONE DIRECTLY OR INDIRECTLY EMPLOYED BY THEM.
- THE CONSTRUCTION DOCUMENTS SHALL BE VALID FOR A PERIOD OF (1) YEAR (BASED ON THE COMPLETION DATE OF THE INITIAL WORKING DRAWINGS). EXPIRED CONSTRUCTION DOCUMENTS SHALL BE REVIEWED BY ARCHITECT FOR NECESSARY REVISIONS DUE TO UPDATED CODES, ORDINANCES, CONSTRUCTION TECHNIQUES, ETC.
- THESE PLANS SHALL NOT BECOME FINAL UNTIL APPROVED BY ALL LOCAL (AND OTHER RELEVANT) DEPARTMENTS, AGENCIES, ETC.; THEREFORE, NO WORK SHALL COMMENCE UNTIL ISSUANCE OF ALL REQUIRED PERMITS.

NOTE: A SMOKE DETECTOR SYSTEM MEETING THE REQUIREMENTS OF NFPA 72 WILL BE INSTALLED IN THE DWELLING. THIS WILL INCLUDE (1) SMOKE DETECTOR IN EACH BEDROOM, (1) WITHIN 10'-0" OF EACH BEDROOM DOOR AND (1) IN EACH STORY. THE SMOKE DETECTORS WILL INCLUDE BATTERY BACK-UP AND WILL BE INTERCONNECTED IN SUCH A MANNER THAT THE ACTUATION OF ONE ALARM WILL ACTUATE ALL OF THE ALARMS.

NOTE: A CARBON MONOXIDE ALARM(S) SHALL BE INSTALLED. THIS ALARM(S) CAN BE BATTERY, PLUG IN OR HARDWIRED TYPE. THE ALARM(S) SHALL BE PLACED IN THE COMMON AREA IN THE VICINITY OF ALL BEDROOMS.

NOTE: ALL WINDOW & DOOR HEADERS TO BE (2)2"x10" UNLESS NOTED OTHERWISE

NOTE: ALL TJI JOISTS, PARALLAMS, AND/OR MICROLLAMS SHALL NOT BE KNOTCHED, CUT, AND/OR DRILLED WITHOUT PRIOR APPROVAL BY ARCHITECT OR MANUFACTURER.

## SIMPSON CONNECTOR TABLE **RADON NOTES:**

LUS28-2

ABU44

BCU4

ABU66

TSP

H16

H10-A. H10-2

IUS2.37/9.5

SUR/L2.37/9

IUS2.37/11.88

SUR/L2.37/1

| MIT3511.88-2

United States ENERGY STAR®

Climate Zone Criteria

WINDOWS MAX. REQUIREMENTS

ZONE 5 ≤ 0.27 Any Prescriptiv

= 0.28 ≥ 0.32 = 0.29 ≥ 0.37 Equivalent

= 0.30 ≥ 0.42

U-Factor<sup>1</sup> SHGC<sup>2</sup>

¹ Btu/h ft².℉


No Rating ≤ 0.25

**ZONE 4** ≤ 0.30 ≤ 0.40

DOORS MAX. REQUIREMENTS

| MIT359.5-2

LUS210-2

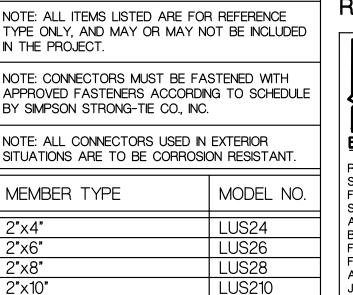

2"x8" DBI

2"x10" DBL

4"x4" POST BASE

4"x4" POST CAP

6"x6" POST BASE

6"x6" POST CAP

HURRICANE ANCHOR

T.J.I. 230 SERIES JOIST

DOUBLE 9 ½" TOP MNT.

DOUBLE 9 ½" FACE MNT. | MIU4.75/9 |

DOUBLE 11 1/4" FACE MNT. MIU4.75/11

ANDERSEN 400 SERIES OR EQUAL, MEETING/EXCEEDING THE FOLLOWING U-FACTOR AND SHGC MAXIMUM ENERGY LOSS REQUIREMENTS \*EBLOW

<u>NOTE:</u>UNLESS OTHERWISE NOTED, ALL WINDOWS & DOORS TO BE ZONE APPROVED

HURRICANE STRAP

9 兆" TOP MOUNT

9 兆 FACE MOUNT

9 兆"SKEWED 45°


11 %" TOP MOUNT

ZONE

%" FACE MOUNT

11 %" SKEWED 45°
DOUBLE 11 %" TOP MNT.

HURRICANE TIE

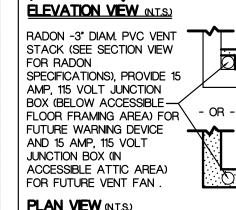

RADON VENT PIPE

PLAN VIEW (N.T.S.) 3" DIAM. "T" FITTING WITH THE HORIZONTAL OPENINGS OF THE "T" FITTING INSTALLED IN THE SUB-SLAB AGGREGATE. THE VERTICAL PORTION OF THE "T" PIPE FITTING SHALL BE CONNECTED TO A 3" DIAM. SOLID VENT PIPE. VENT PIPE TO BE INDEPENDENT OF OTHER VENTS & BE GAS TIGHT. END VENT PIPE 10'-0" MIN. ABOVE GRADE & FROM ADJACENT BUILDINGS- VENT TO CONFORM TO PLUMBING CODES. —

— 4" OR 2" CONC. SLAB 2011 No. 2012 APRIL APRIL 1973 ∠6-MIL. POLY. VAPOR BARRIER W/ JOINTS LAPPED 12"MIN.

4" COMPACT GRAVEL (NOT -


& STACKS (ONE @ UPPER & ONE @ LOWER)

MORE THAN 10% THRU #4 SIEVE) SECTION VIEW (N.T.S.) NOTE: PROVIDE (2) SEPARATE RADON "T" FITTINGS

**OWNER:** 


CHAD M. ROSSBACH

# **ELECTRICAL LEGEND**

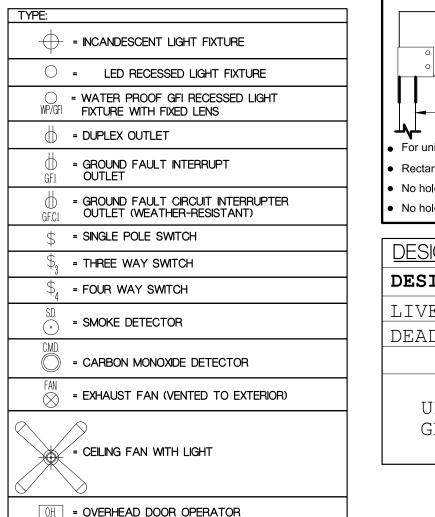

\* ALL THE ITEMS INDICATED IN THE LEGEND MAY NOT BE INCLUDED IN THIS PROJECT \* NOTE: ALL RECEPTACLES SHALL BE TAMPER-RESISTANT ELECTRICAL RECEPTACLES PER REFERENCED ELECTRICAL


NOTE: INCLUDE "ARC-FAULT" CIRCUIT BREAKERS PER REFERENCED ELECTRICAL CODE

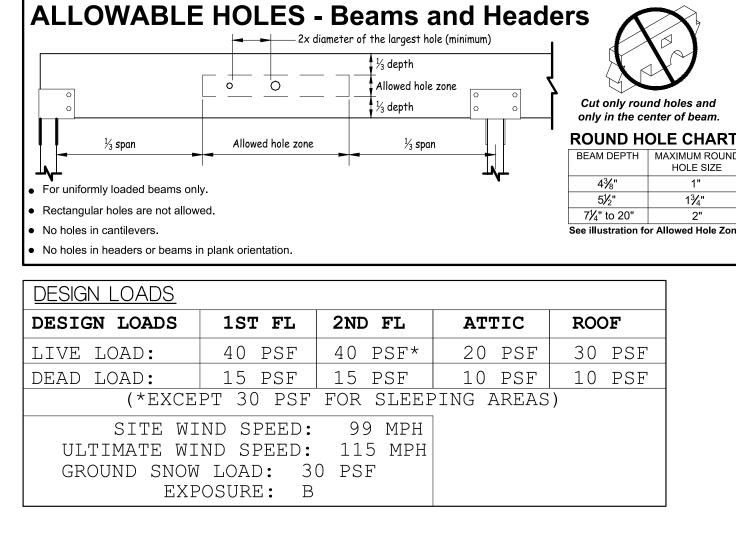



### **PARTITION LEGEND**


= 2"X4"-16" O.C. AND 2"x6"-16" O,C,

CMU BLOCK

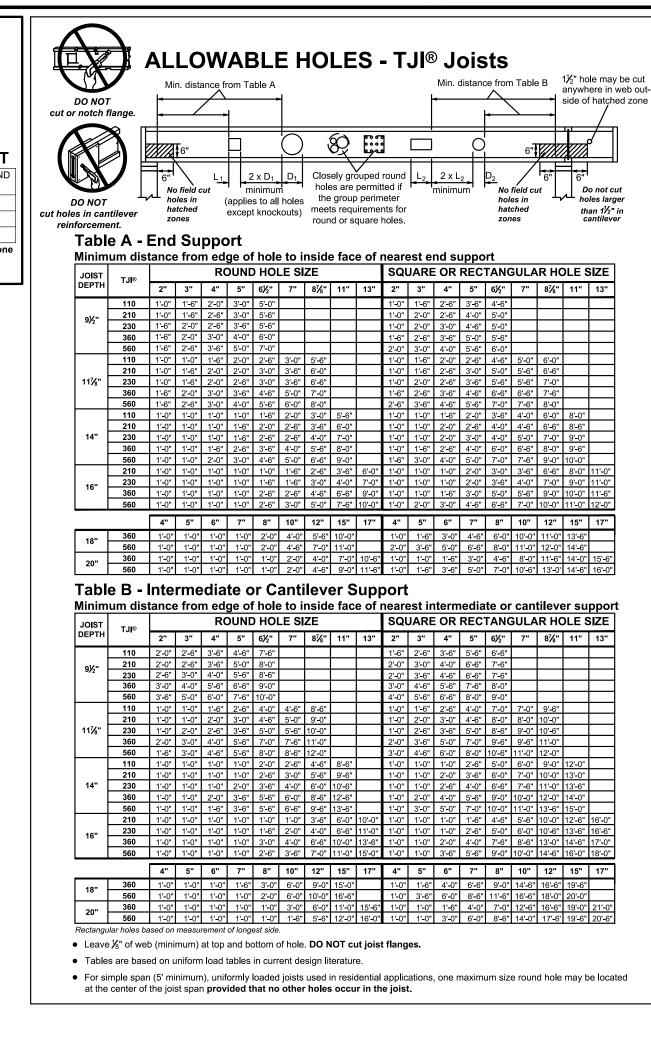

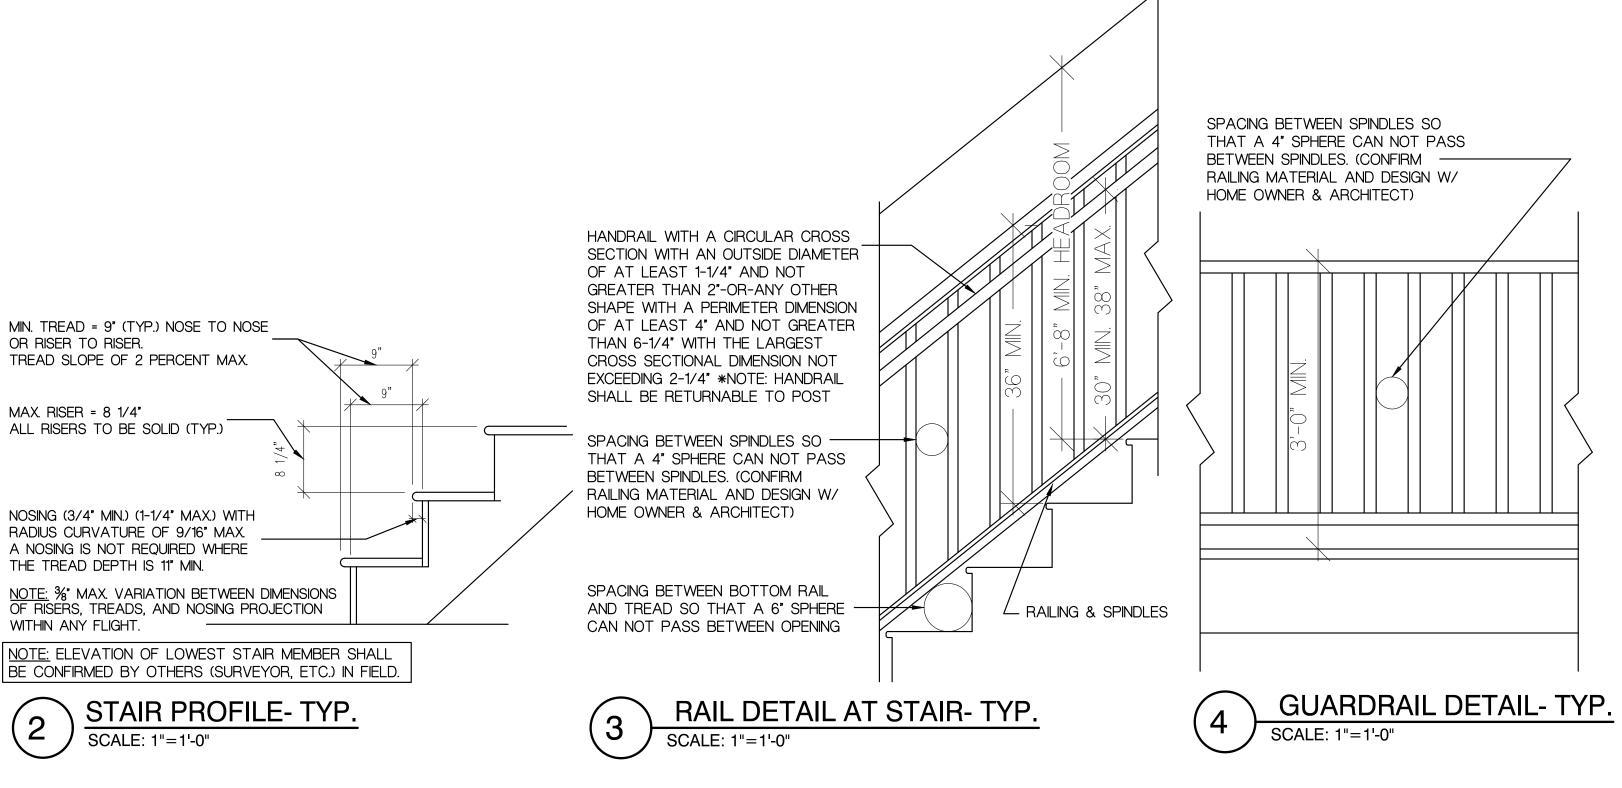

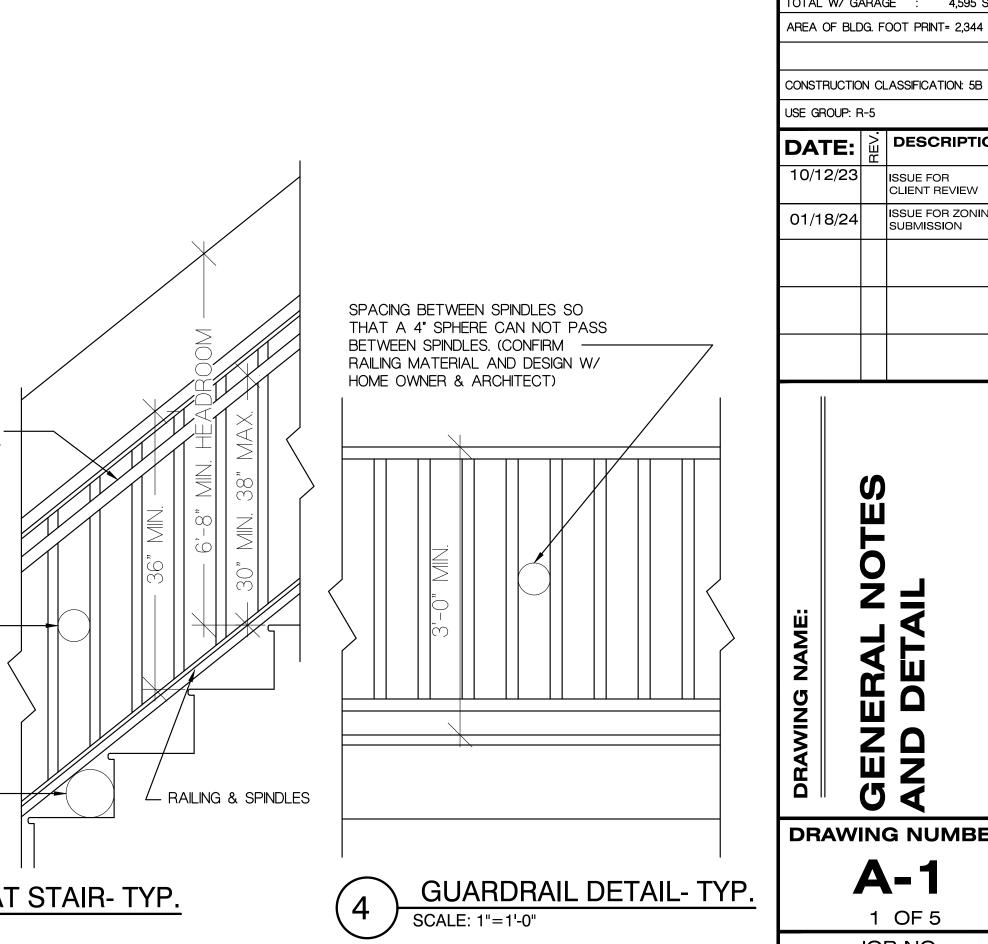

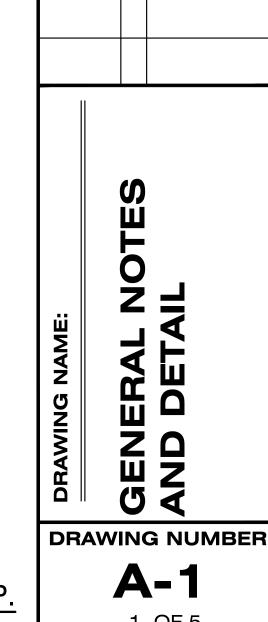

JOB NO.

23-144K

(732) (732) ( Kjlud

Ludw vrchitec

N/J CERT.N/D.#AI-11708

NY LIC. NO. 034741-1

REGISTERED ARCHITECT

E FAMILY DWEL
SESIDENCE
TREET
CK 449.0

BUILDING DATA

AREA OF BLDG. FOOT PRINT= 2,344 S.F

4,018 S.F.

2.344 S.F)

2,251 S.F.

4,595 S.F.

DESCRIPTION

ISSUE FOR ZONING

ISSUE FOR CLIENT REVIEW

SUBMISSION

LIVING SPACE AREA: 1ST FLR. W/O GARAGE:

TOTAL W/O GARAGE

(1ST FLR. W/ GARAGE

TOTAL W/ GARAGE


AREA (W/ GARAGE):


2ND FLOOR

01/18/24

0

Kurt J. Ludwig, AIA Architect

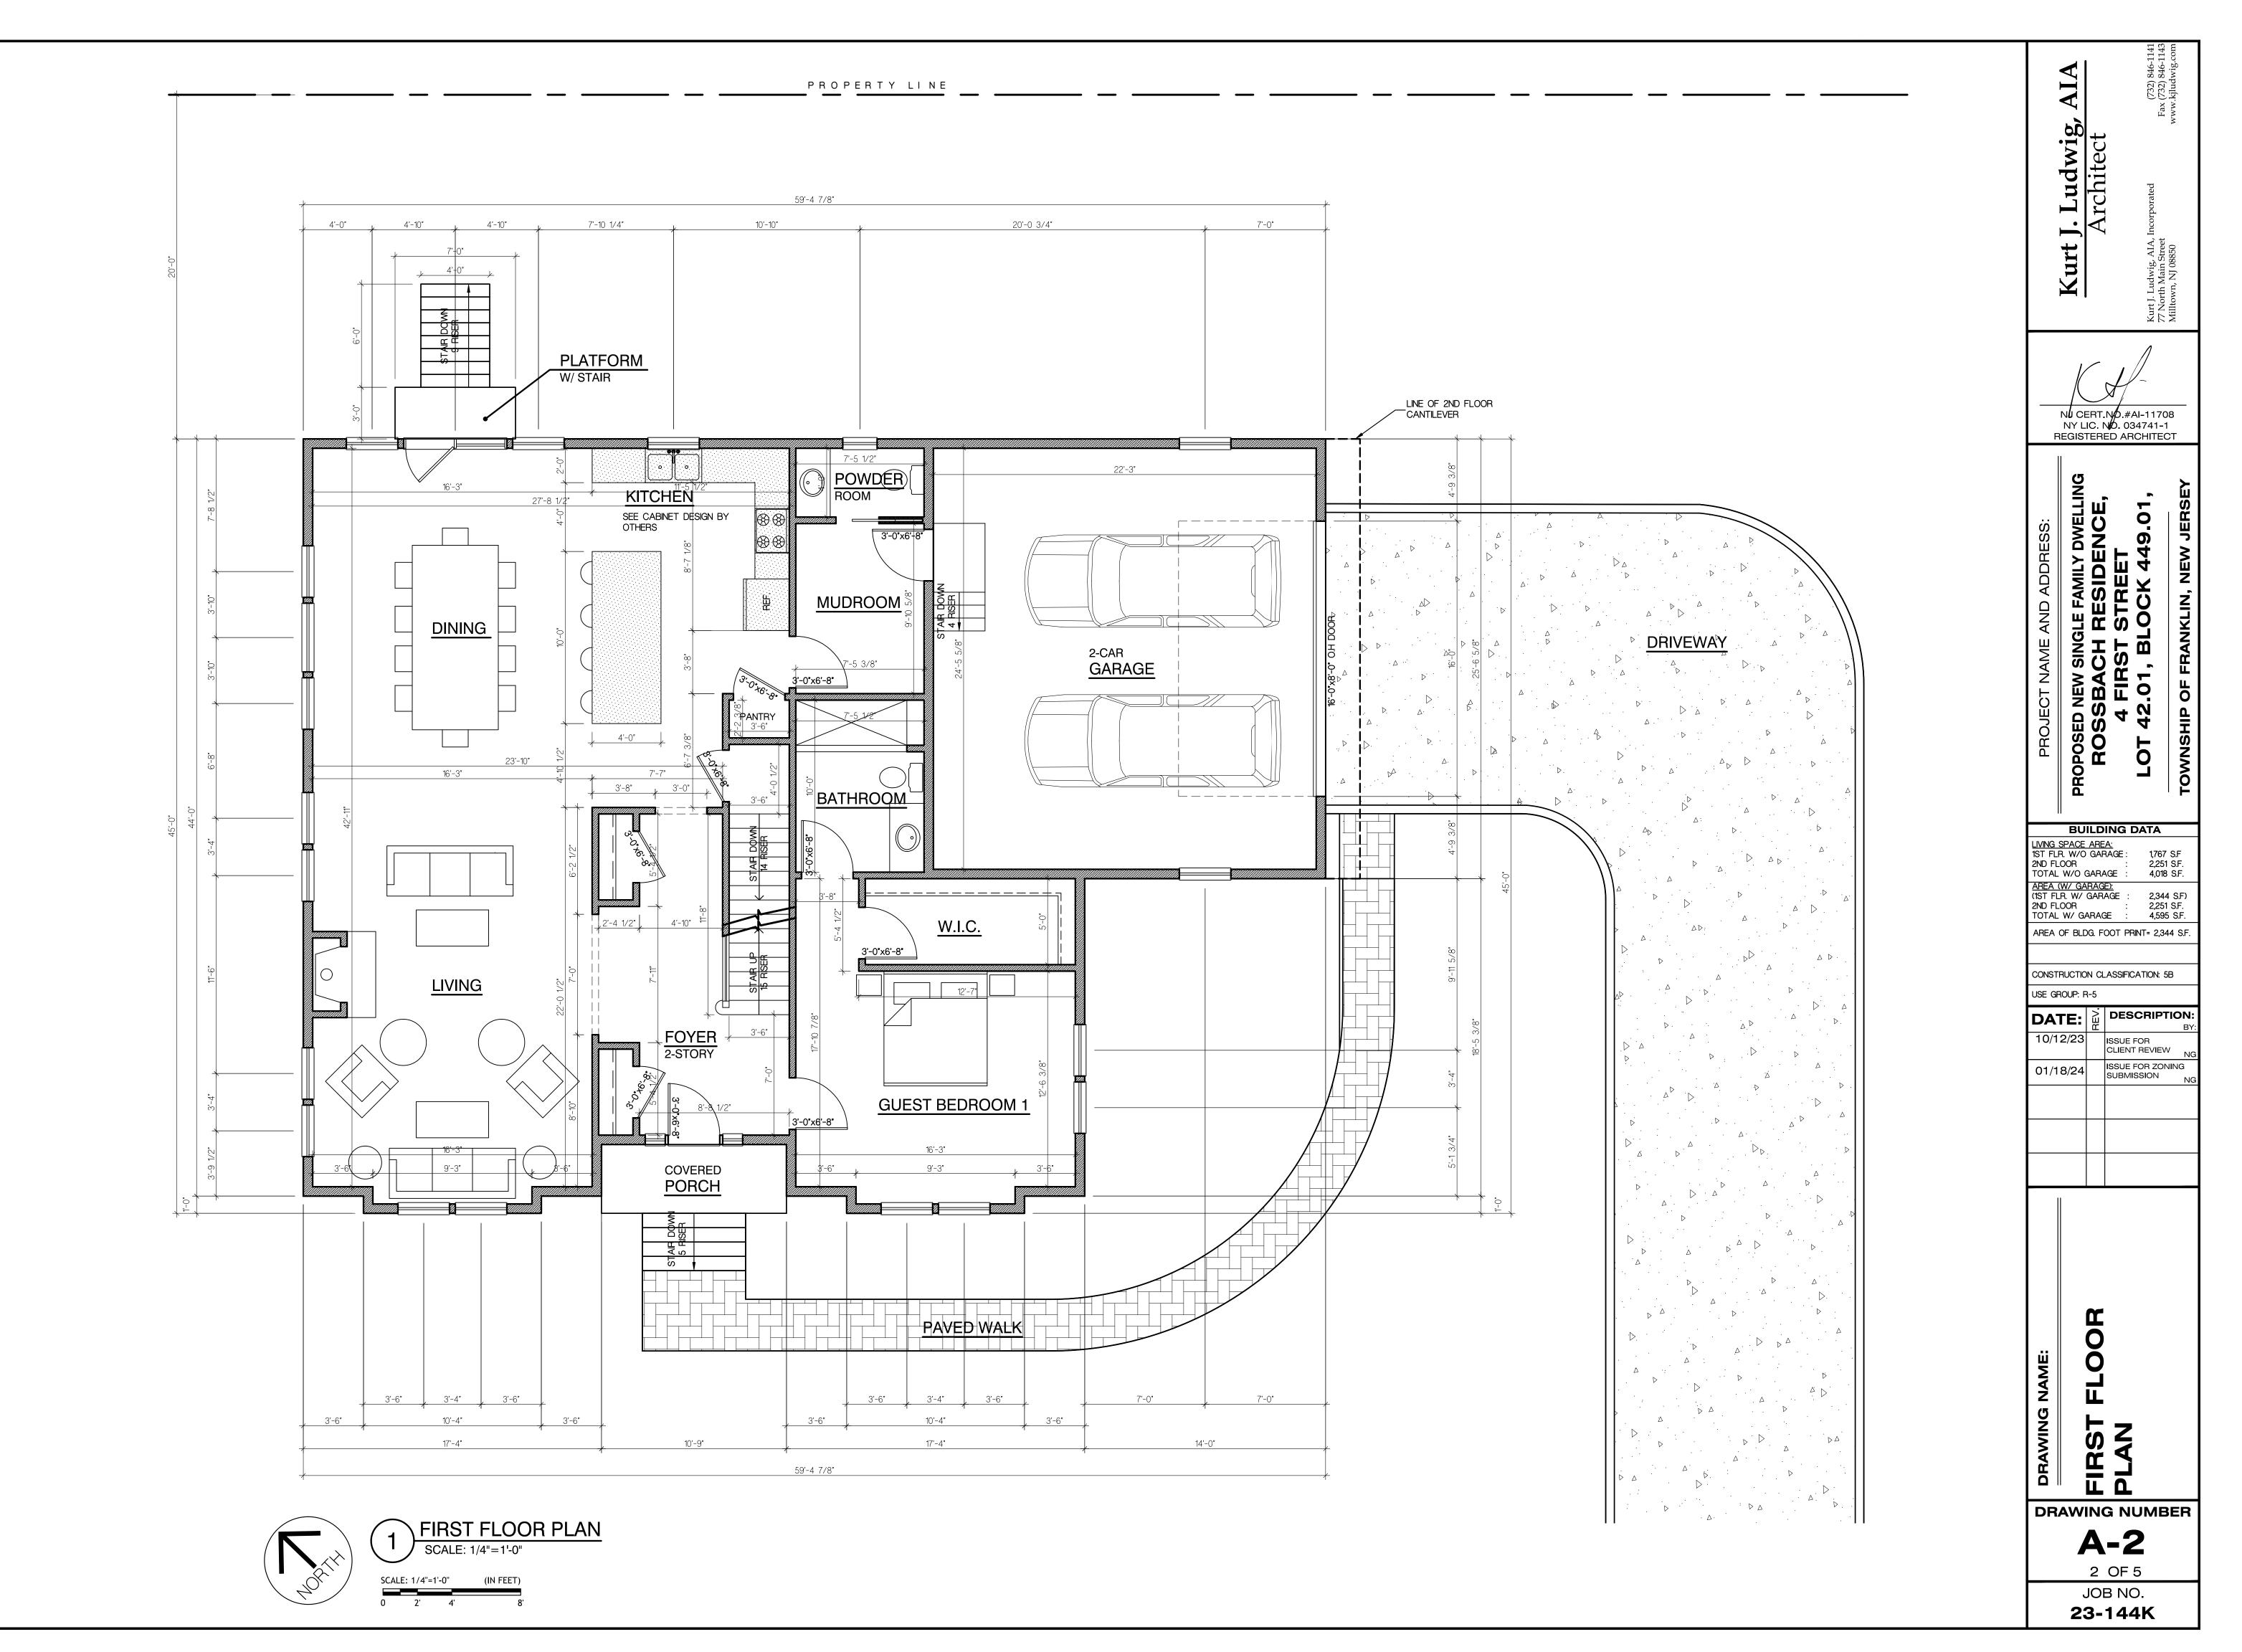

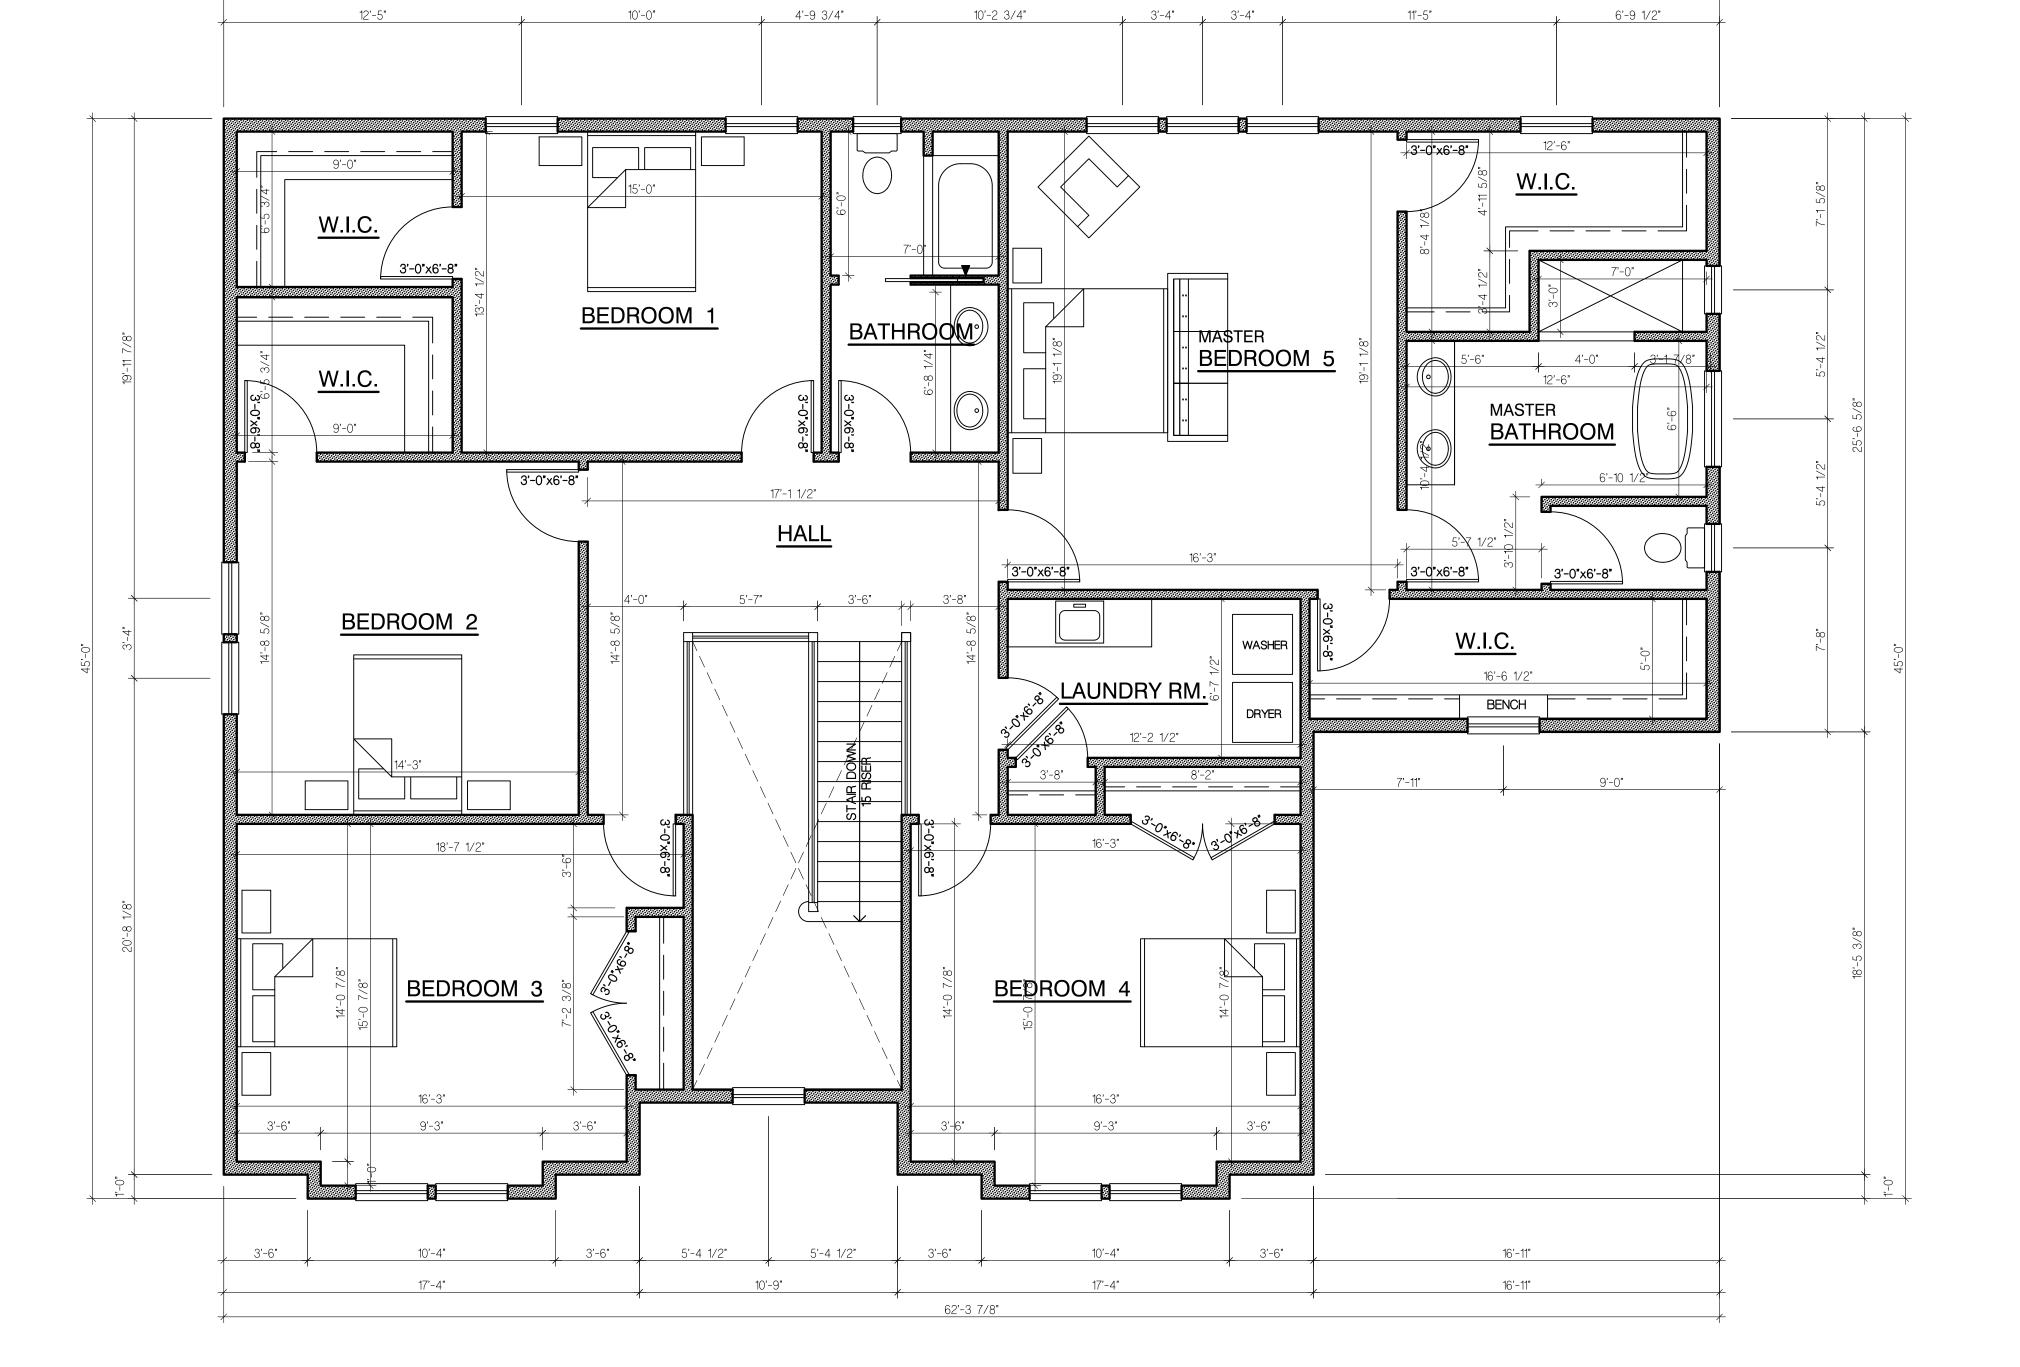

SECOND FLOOR PLAN

SCALE: 1/4"=1'-0" (IN FEET)

62'-3 7/8"

Kurt J. Ludwig, Architect NU CERT.NO.#AI-11708 NY LIC. NO. 034741-1 REGISTERED ARCHITECT **BUILDING DATA** <u>LIVING SPACE AREA:</u> 1ST FLR. W/O GARAGE: 2ND FLOOR : 2,251 S.F.
TOTAL W/O GARAGE : 4,018 S.F.

AREA (W/ GARAGE):
(1ST FLR. W/ GARAGE : 2,344 S.F)
2ND FLOOR : 2,251 S.F.
TOTAL W/ GARAGE : 4,595 S.F. AREA OF BLDG. FOOT PRINT= 2,344 S.F. CONSTRUCTION CLASSIFICATION: 5B USE GROUP: R-5 DESCRIPTION: DATE: ISSUE FOR CLIENT REVIEW ISSUE FOR ZONING SUBMISSION 01/18/24


SECOND FLOOR
PLAN


DRAWING NUMBER

**A-3** 3 OF 5

JOB NO. **23-144K** 



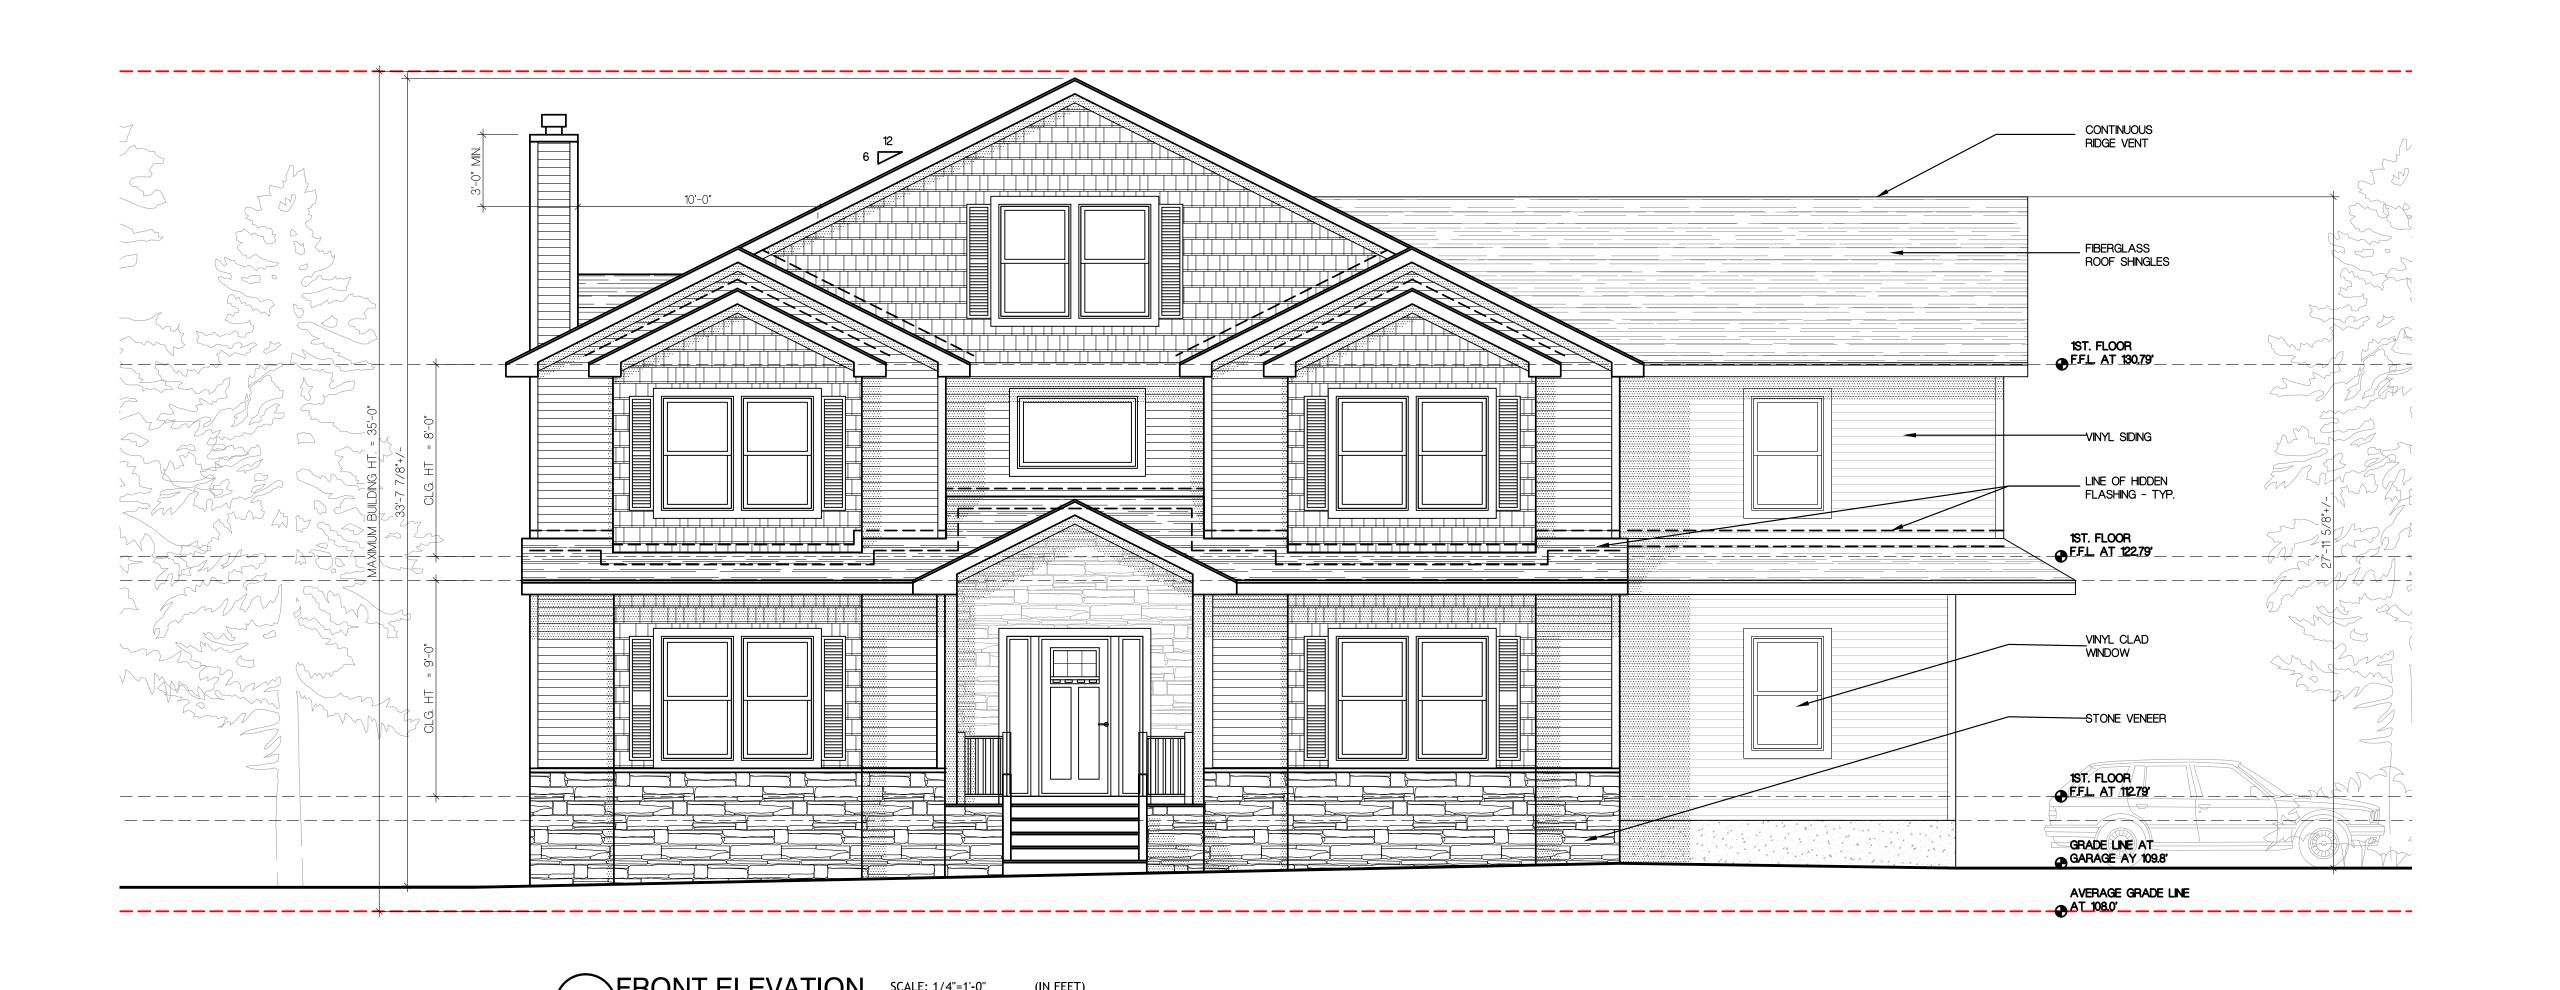

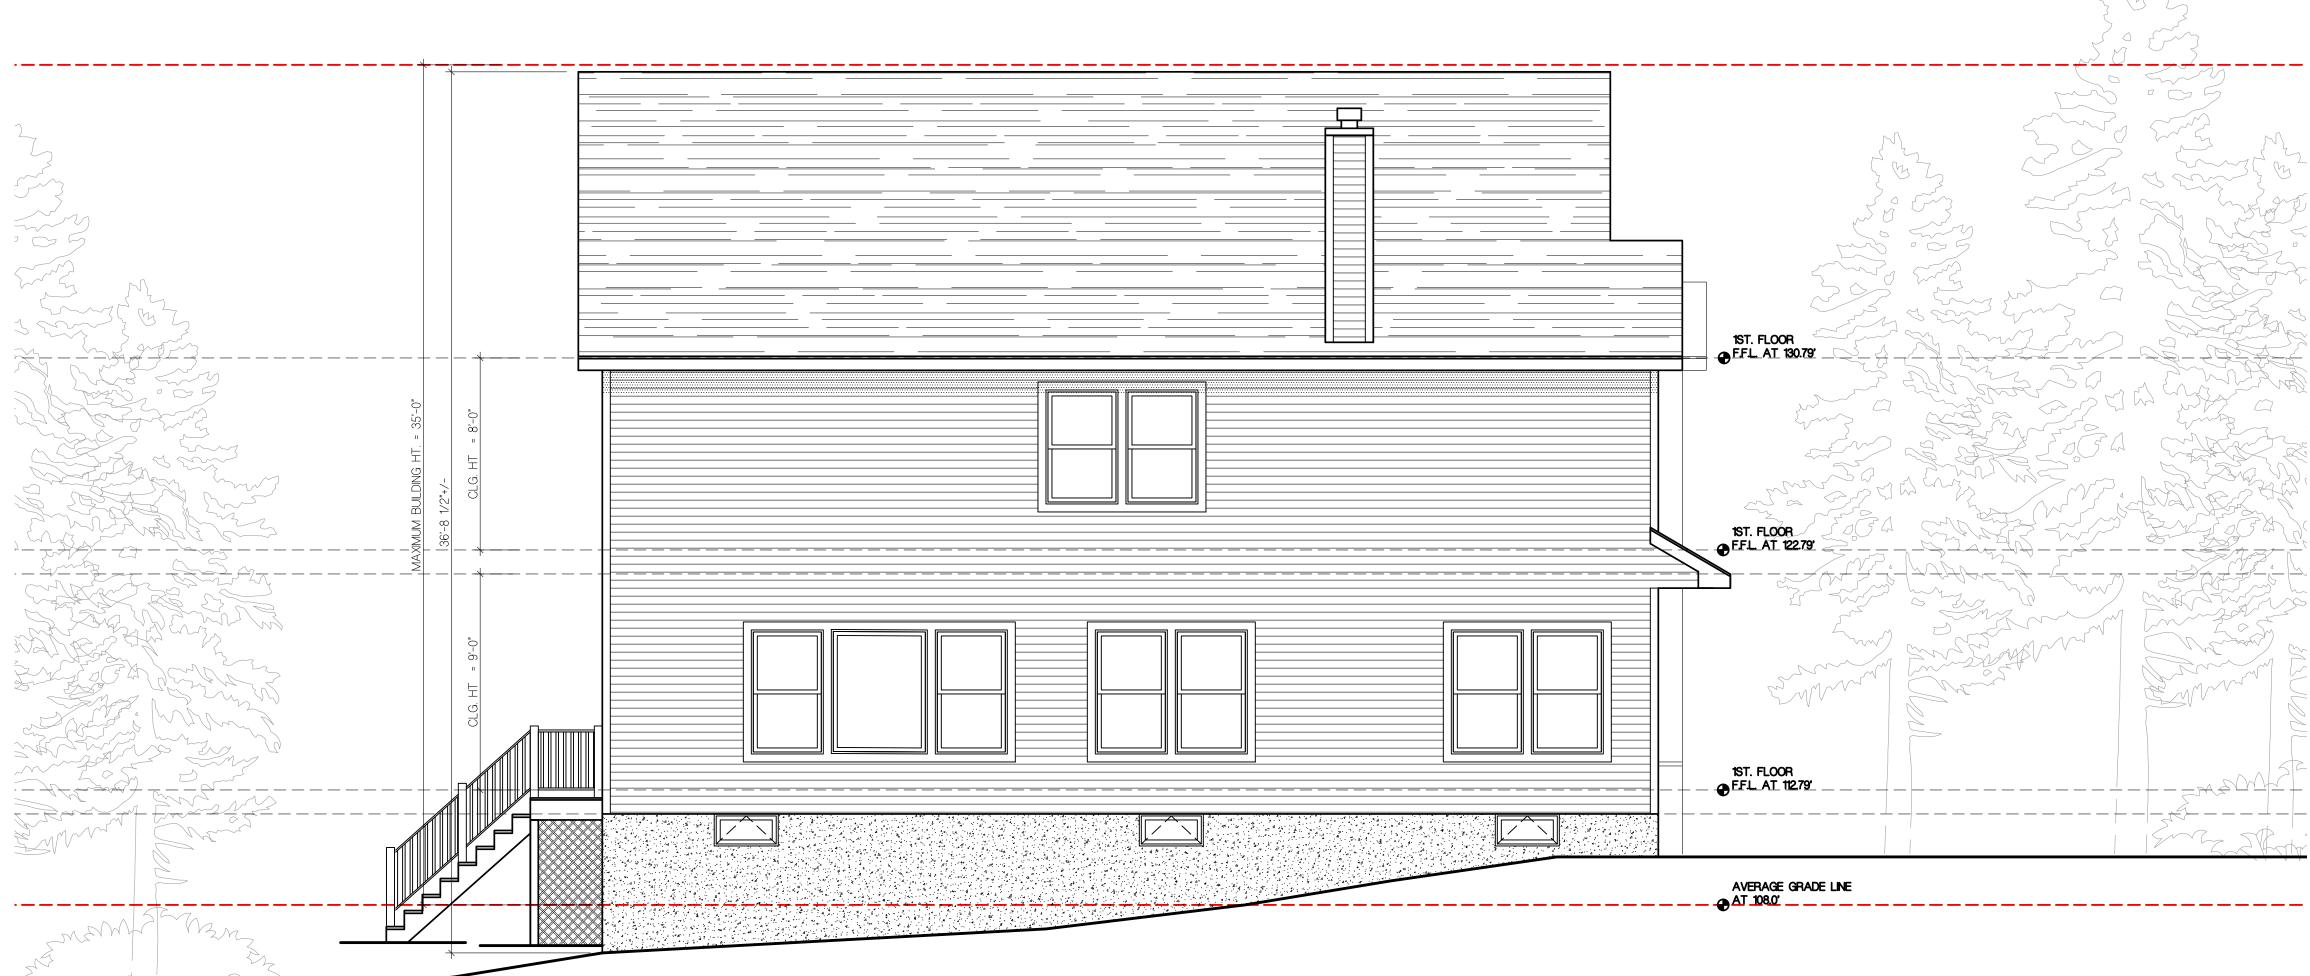



NY LIC. NO. 034741-1 REGISTERED ARCHITECT

J. Ludwig, Architect

2ND FLOOR : 2,251 S.F.
TOTAL W/O GARAGE : 4,018 S.F.

AREA (W/ GARAGE):
(1ST FLR. W/ GARAGE : 2,344 S.F)
2ND FLOOR : 2,251 S.F.
TOTAL W/ GARAGE : 4,595 S.F. AREA OF BLDG. FOOT PRINT= 2,344 S.F CONSTRUCTION CLASSIFICATION: 5B USE GROUP: R-5

<u>LIVING SPACE AREA:</u> 1ST FLR. W/O GARAGE:

**BUILDING DATA** 

ISSUE FOR CLIENT REVIEW ISSUE FOR ZONING SUBMISSION 01/18/24

DRAWING NUMBER

5 OF 5 JOB NO.

23-144K

